

MANUFACTURING/SALES PREMIER BUILDING SYSTEMS, LLC. 18504 Canyon Rd E. PUYALLUP, WA 98375 OFFICE-800.275.7086

NOTES:

U.C. DAVIS HWQLHC

UNIVERSITY OF CALIFORNIA, DAVIS | HOT WATER QUAD LOOP AND HUTCHISON CONVERSION CAMPUS HEAT EXCHANGER AND DISTRIBUTION PIPING

GENERAL NOTES

- PREMIER IS A MATERIAL SUPPLIER AND NOT A BUILDER. PROPER INSTALLATION OF OUR PRODUCT SHOULD BE DONE BY A QUALIFIED CONTRACTOR. IT IS THE CONTRACTORS RESPONSIBILITY TO COMPLY WITH ALL APPLICABLE AND LOCAL CODES AND REGULATIONS.
- SHOP DRAWINGS ARE PREMIER'S INTERPRETATION OF THE PLANS PROVIDED. THE CONTRACTOR SHALL REVIEW ALL SHOP DRAWINGS AND VERIFY ALL DIMENSIONS WITH ARCHITECT. PANELS ARE FABRICATED PER THESE SHOP DRAWINGS. ANY DISCREPANCIES OR MISSING ITEMS IN THESE SHOPS SHOULD BE NOTED
- PREMIER SHOP DRAWINGS ARE TO BE USED IN CONJUNCTION WITH ARCHITECTURAL AND STRUCTURAL DRAWINGS. IF ANYTHING IS NOT CLEAR OR THERE ARE QUESTIONS THEY SHOULD BE IMMEDIATELY DIRECTED TO THE
- CONTRACTOR SHOULD LOOK THROUGH THE PLANS CAREFULLY TO INSURE THAT ALL ASPECTS OF SIP PACKAGE CAN BE CONSTRUCTED THROUGH THEIR PREFERRED MEANS AND METHODS PRIOR TO SIGNING OFF ON THE SHOP
- EXECUTION OF WORK FOR SIP PACKAGE MAY REQUIRE COORDINATION WITH OTHER TRADES (I.E. ELECTRICIAN, HVAC, WINDOW/DOOR MANUFACTURER, ETC...). THIS COORDINATION IS THE RESPONSIBILITY OF THE CONTRACTOR
- IT IS THE CONTRACTOR'S SOLE RESPONSIBILITY TO ENSURE THAT ALL SPLINES ARE PROPERLY SEATED INTO THE PANEL RECESSES AND COMPLETELY SEALED WITH MASTIC OR EXPANDING SPRAY FOAM, INCLUDING BUT NOT LIMITED TO SPLINE JOINTS, PENETRATIONS, LIFTING HOLES, ETC. VOIDS BETWEEN SPLINE JOINTS ARE NOT ACCEPTABLE IN A PROPER SIP INSTALLATION
- THE CONTRACTOR IS RESPONSIBLE TO DETERMINE THE PROPER WEATHER BARRIER (I.E. HOUSE WRAPS, FLASHING, ROOF UNDERLAYMENT, ETC...) TO DRY IN THE BUILDING ENVELOPE.
- SOME DIMENSIONS CAN NOT BE VERIFIED UNTIL CONSTRUCTED. THEREFORE PREMIER TAKES NO RESPONSIBILITY FOR FIELD FABRICATION. SOME FIELD FABRICATED AREAS MAY HAVE BEEN HIGHLIGHTED ON THE DRAWINGS BUT MAY NOT BE LIMITED TO ONLY THOSE AREAS
- YOU MAY EXPERIENCE DIMENSIONAL VARIANCES FROM THE CONSTRUCTION DRAWINGS AS PANELS ARE ASSEMBLED DUE TO GAPS AT PANEL JOINTS AND ADDITIONAL MISCELLANEOUS CONSTRUCTION VARIABLES SUCH AS FABRICATION TOLERANCES, LUMBER POST THICKNESS VARIANCES, ETC. FIELD CUTTING THE SIPS MAY BE REQUIRED TO ENSURE THAT THE TOTAL WALL OR ROOF ASSEMBLY IS PER THE CONSTRUCTION DRAWINGS. PREMIER WILL ADD GAPS AS INDICATED ON PANEL LAYOUTS BETWEEN PANEL JOINTS IN THE SHOP DRAWINGS
- 10. IT IS THE BUILDERS RESPONSIBILITY TO DETERMINE ALL MATERIALS NECESSARY FOR PANEL INSTALLATION. THIS INCLUDES VERIFYING THAT THE MATERIALS PREMIER WILL BE PROVIDING ARE ADEQUATE FOR THE PROJECT AND SOURCE ANY ADDITIONAL MATERIALS REQUIRED FOR PANEL INSTALLATION THAT ARE NOT PROVIDED BY PREMIER.
- 11. PANEL WALL AND/OR ROOF LAYOUTS INCLUDE LOCATIONS OF FACTORY ELECTRICAL CHASES AS INDICATED IN THE LEGEND BELOW. ADDITIONAL "CUSTOM" ELECTRICAL CHASES MAY BE ADDED FOR A FEE.


REVIEWING PANEL LAYOUT **DRAWINGS**

TWO ROUNDS OF REVISIONS/EDITS ARE INCLUDED IN THE INITIAL PRE-PRODUCTION SERVICES PORTION OF THE PBS ESTIMATE. ADDITIONAL REVISIONS MAY INCUR ADDITIONAL FEES.

WHEN REVIEWING SHOP DRAWINGS, BEGIN BY CHECKING ALL OF THE OVERALL DIMENSIONS OF THE PROJECT. IF THE PROJECT HAS FLOOR PANELS, PLEASE CHECK POINT LOAD LOCATIONS FOR SOLID BLOCKING AND MAKE SURE ANY OPENINGS OR STEP DOWNS ARE CORRECT. AFTER THE FLOORS HAVE BEEN COMPLETELY CHECKED, MOVE TO THE WALLS. THE WALLS WILL BE SHOWN ON A KEYED FLOOR PLAN WITH WALL NUMBERS CALLED OUT AND AN ARROW POINTING THE VIEW DIRECTION OF EACH OF THE PANEL WALI LAYOUTS. THESE NUMBERS AND THEIR ORIENTATION WILL ALSO BE LOCATED BELOW EVERY PANELIZED WALL. OBSERVE THE LOCATION OF THE PANEL CORNER LAPS. SOME OF THE WALLS WILL BE SHORTER DUE TO CORNER LAPS AND TO THE PANEL THICKNESS. AFTER YOU HAVE MADE SURE ALL DIMENSIONS MATCH YOUR ARCHITECTURAL PLANS, MOVE TO THE WINDOWS AND DOORS. MAKE SURE THAT THE ROUGH OPENINGS FOR THE WINDOWS AND DOORS ARE THE CORRECT SIZE AND ARE LOCATED PROPERLY. IF THE ROOF FOR THE PROJECT IS ALSO PANELS, CHECK THE ROOF PITCH, RIDGE LOCATION, AND THE OVERHANGS AT THE EAVES AND GABLES. EVEN IF THE ROOF IS A SYSTEM OTHER THAN PANELS, GABLE WALL HEIGHTS MAY BE DEPENDENT ON HEEL HEIGHTS OR BE NOTCHED FOR LOOK OUT SUPPORTS. IF THERE ARE SKYLIGHTS CHECK THE ROUGH OPENINGS FOR CORRECT SIZE AND LOCATION. PANEL DRAWINGS ARE TO BE REVIEWED B AND APPROVED BY CONTRACTOR, CONFIRMING ALL DIMENSIONS. CONTRACTOR IS RESPONSIBLE FOR VERIFYING ALL PANEL DRAWING DIMENSIONS TO ENSURE PROPER ASSEMBLY. CHECK CORRECT DIMENSIONS AND CLOUD CHANGED DIMENSIONS WITH AN APPROPRIATE ARROW REFERENCING THE DIRECTION OF CHANGE. UNCHECKED DIMENSIONS MAY RESULT IN FIELD FABRICATION.


WHEN YOU HAVE FINISHED VERIFYING THE SHOP DRAWINGS AND HAVE MADE ANY CHANGES/CORRECTIONS, COPY THOSE CHANGES TO THE SHOP DRAWINGS AND SEND BACK TO PREMIER FOR REVISIONS.

ANY AND ALL DISCREPANCIES RELATED TO PANELS ON SITE ARE THE RESPONSIBILITY OF CONTRACTOR UNLESS THERE IS A DIFFERENCE BETWEEN FABRICATED PANELS AND SIGNED SHOP DRAWINGS. PREMIER HOLDS FIRST RIGHT OF DECISION TO REPLACE, REPAIR OR PAY FOR REPAIR OF ALL PRODUCTS IN DISCREPANCY WITH FINAL SHOP DRAWINGS.

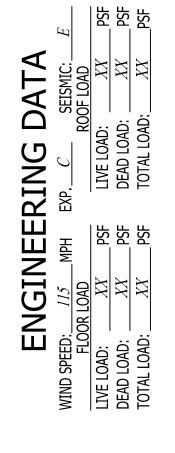

LIST OF DRAWINGS

- TITLE SHEET, PROJECT INFO
- WALL PLAN WALL PANEL LAYOUTS
- 4. PBS DETAILS
- 5. SIP FRAMING ITEMS

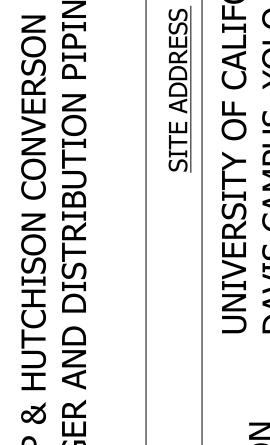

Z

DRAWN BY:

CHECKED BY

R. STOWERS


APRIL 16, 2020

REV.	ISIONS:		
#	DRAFTER	DATE	TYPE
1.	RKS	06/04/20	C-REV
2.	RKS	07/15/20	C-REV
3.	RKS	07/29/20	E-REV
4.	RK	07/30/2020	FINAL
_			

DELIVERY & STORAGE

IN ORDER TO KEEP YOUR FREIGHT COSTS TO A MINIMUM AND MAKE THE MOST EFFICIENT USE OF THE SPACE AVAILABLE ON A TRUCK, WE TYPICALLY DO NOT SHIP PANELS IN NUMERICAL SEQUENCE. BEAR IN MIND THAT ALL PANELS HAVE MARKINGS WHICH DO MAKE FOR A SMOOTH IDENTIFICATION PROCESS. HOWEVER, IF YOU DESIRE A SPECIAL LOADING PLAN, THAT REQUEST, AND LAYOUT, MUST BE MADE CONCURRENT WITH THE RETURN OF THE SIGNED SHOP DRAWINGS AND MAY BE SUBJECT TO AN ADDITIONAL FEE. PANELS ARE FABRICATED AT 4' & 8' WIDTHS AND UP TO 24' LENGTHS. 6' FORKS ARE REQUIRED FOR 8' WIDE PANELS (REFER TO THE CONTRACT OF SALE FOR MORE INFORMATION OR ASK PREMIER FOR A DELIVERY INFORMATION SHEET). ALL PANELS SHALL BE STORED IN A PROTECTED AREA AND SUPPORTED EVERY 4' TO PREVENT DEFORMATION AND CONTACT WITH THE GROUND. DO NOT USE A BLACK OR DARK COLORED TARP. PRIOR TO INSTALLATION, ALL PANELS SHALL BE COVERED TO PREVENT CONTACT WITH WATER ON ALL EXPOSED PANEL EDGES.

LEGEND/ABBREVIATIONS

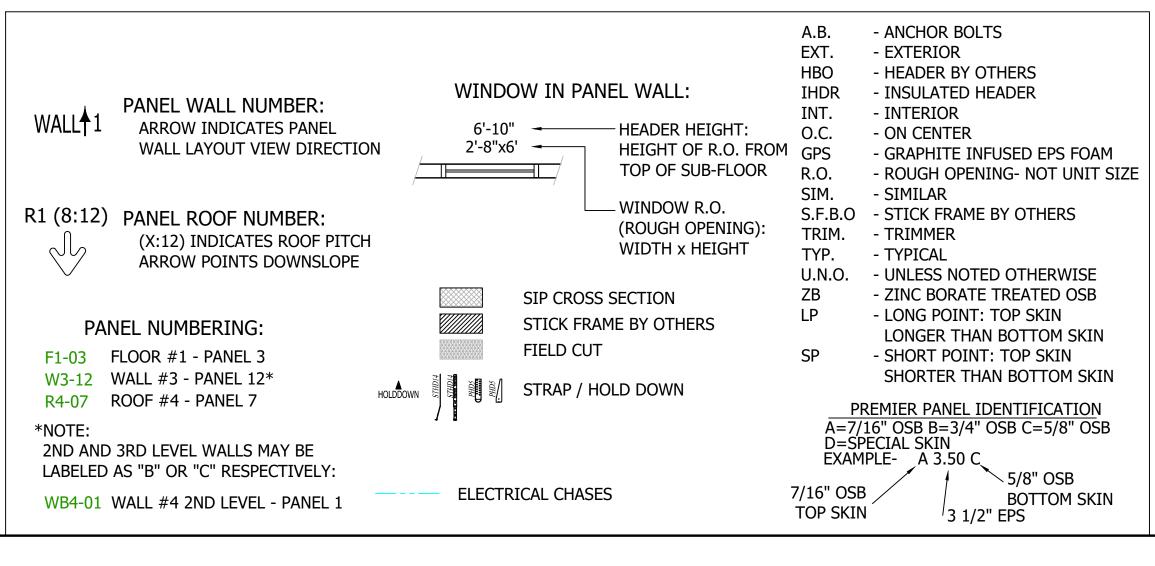

THIS PROJECT UTILIZES THE FOLLOWING PANEL TYPES

REMIER WALL TYPE C3.50C ZB

SIGN HERE **PLEASE**

DATE CUSTOMER'S SIGNATURE

AS A SUPPLIER OF MATERIALS ONLY, PREMIER SIPS DOES

NOT ASSUME RESPONSIBILITY FOR ERRORS IN DESIGN,

(ARCHITECT, CONTRACTOR, AND/OR INSTALLER) SHALL

VERIFY ALL DIMENSIONS AND SIZES, AND BY SIGNING THESE

PLANS, THE CONTRACTOR TAKES FULL RESPONSIBILITY FOR


ENGINEERING, OR DIMENSIONS. OWNER/AGENT

ot REVISE & RESUBMIT APPROVED WITH REVISIONS AS NOTED IN RED

APPROVED AS DRAWN

THEIR ACCURACY.

- 1. ROUGH OR SMOOTH OSB DOES NOT DENOTE INTERIOR OR EXTERIOR OF SIP. REFER TO PANEL LAYOUTS FOR PANEL ORIENTATION.
- 2. ALL IN-PLANE, PANEL-TO-PANEL JOINTS PBS-005 U.N.O
- 3. INSULATED HEADERS (IHDR-2 PLY) ARE CUT TO 1' INCREMENTS ROUNDED UP FROM THE REQUIRED ROUGH OPENING. (IF YOU'RE ABOUT TO CUT OFF MORE THAN 1' OF INSULATED HEADER THEN YOU'RE CUTTING THE WRONG ONE).
- 4. STANDARD DETAILS PROVIDED FOR TYPICAL INSTALLATION METHODS. REFERENCE ARCHITECTURAL AND STRUCTURAL DRAWINGS FOR JOB SPECIFIC CONNECTION DETAILS, WHICH TAKE PRECEDENT OVER PBS TYPICAL DETAILS.
- 5. FACTORY INSTALLED LUMBER (IF REQUESTED BY CUSTOMER) WILL BE HIGHLIGHTED IN RED IN THE SIP PANEL LAYOUTS.
- 6. STANDARD WALL ELECTRICAL CHASES ARE NOT INCLUDED.

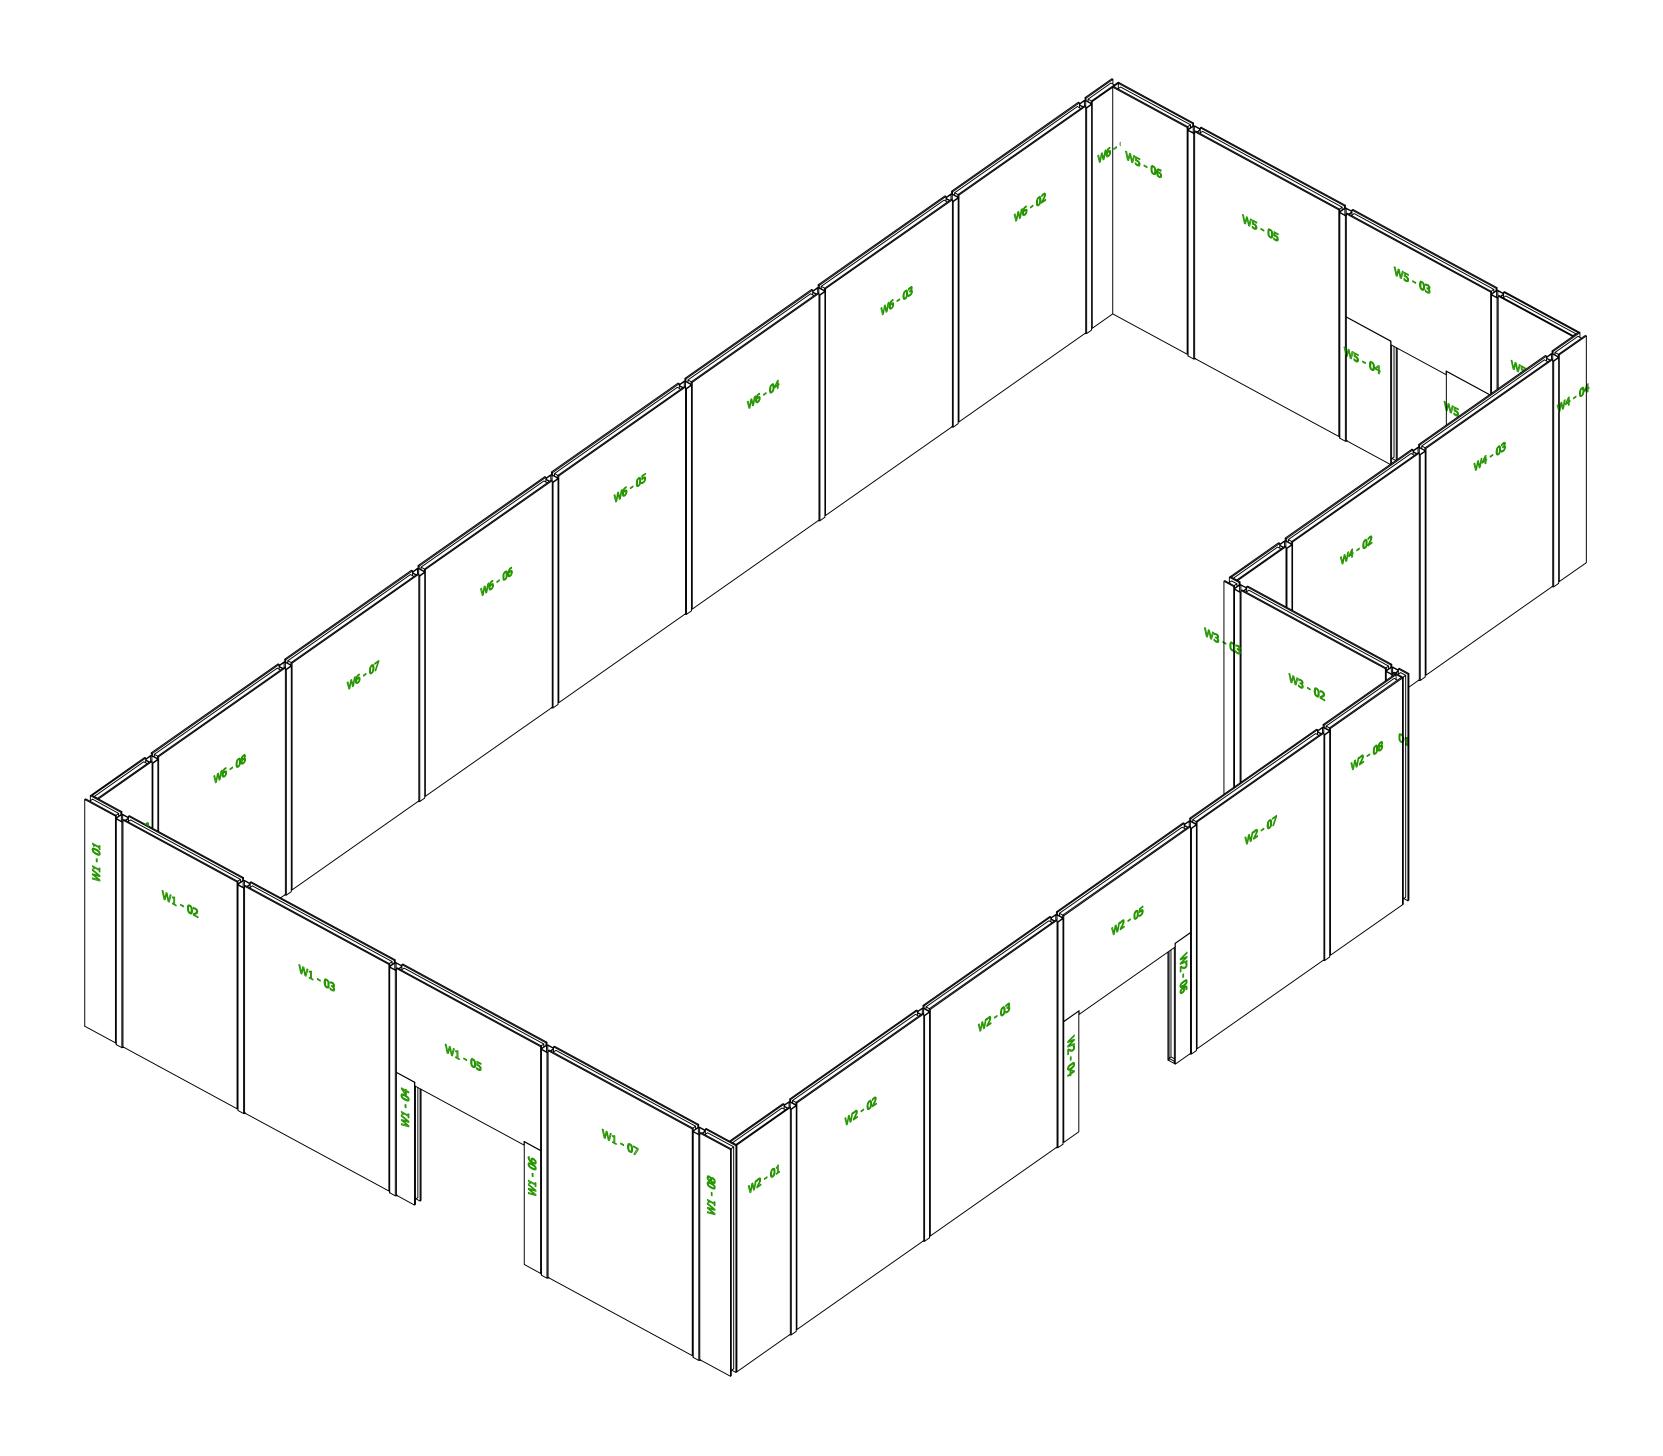


26'-33" 9'-6" 8'-9<u>3</u>" 17'-6" "₽\£ ₽-'8 "₽\\$ P-'8 HSS 5x5x3/8"
BY OTHERS (TYP) 6'-4 1/2" 6'-1"x7'-1 1/4" WALL↑1 14'-5<u>3</u>" 35'-9³"

Panel Wall Plan
4 7/8" Panels 1/4" = 1'-0"

18504 Canyon Rd. E. Puyallup, Wa 98375 800-275-7086

REV.	REVISIONS:		
#	DRAFTER	DATE	ТҮРЕ
1.	RKS	06/04/20	C-REV
2.	RKS	07/15/20	C-REV
3.	RKS	07/29/20	E-REV
4.	RK	07/30/2020	FINAL
5.			

PLAN WALL **PANEL**

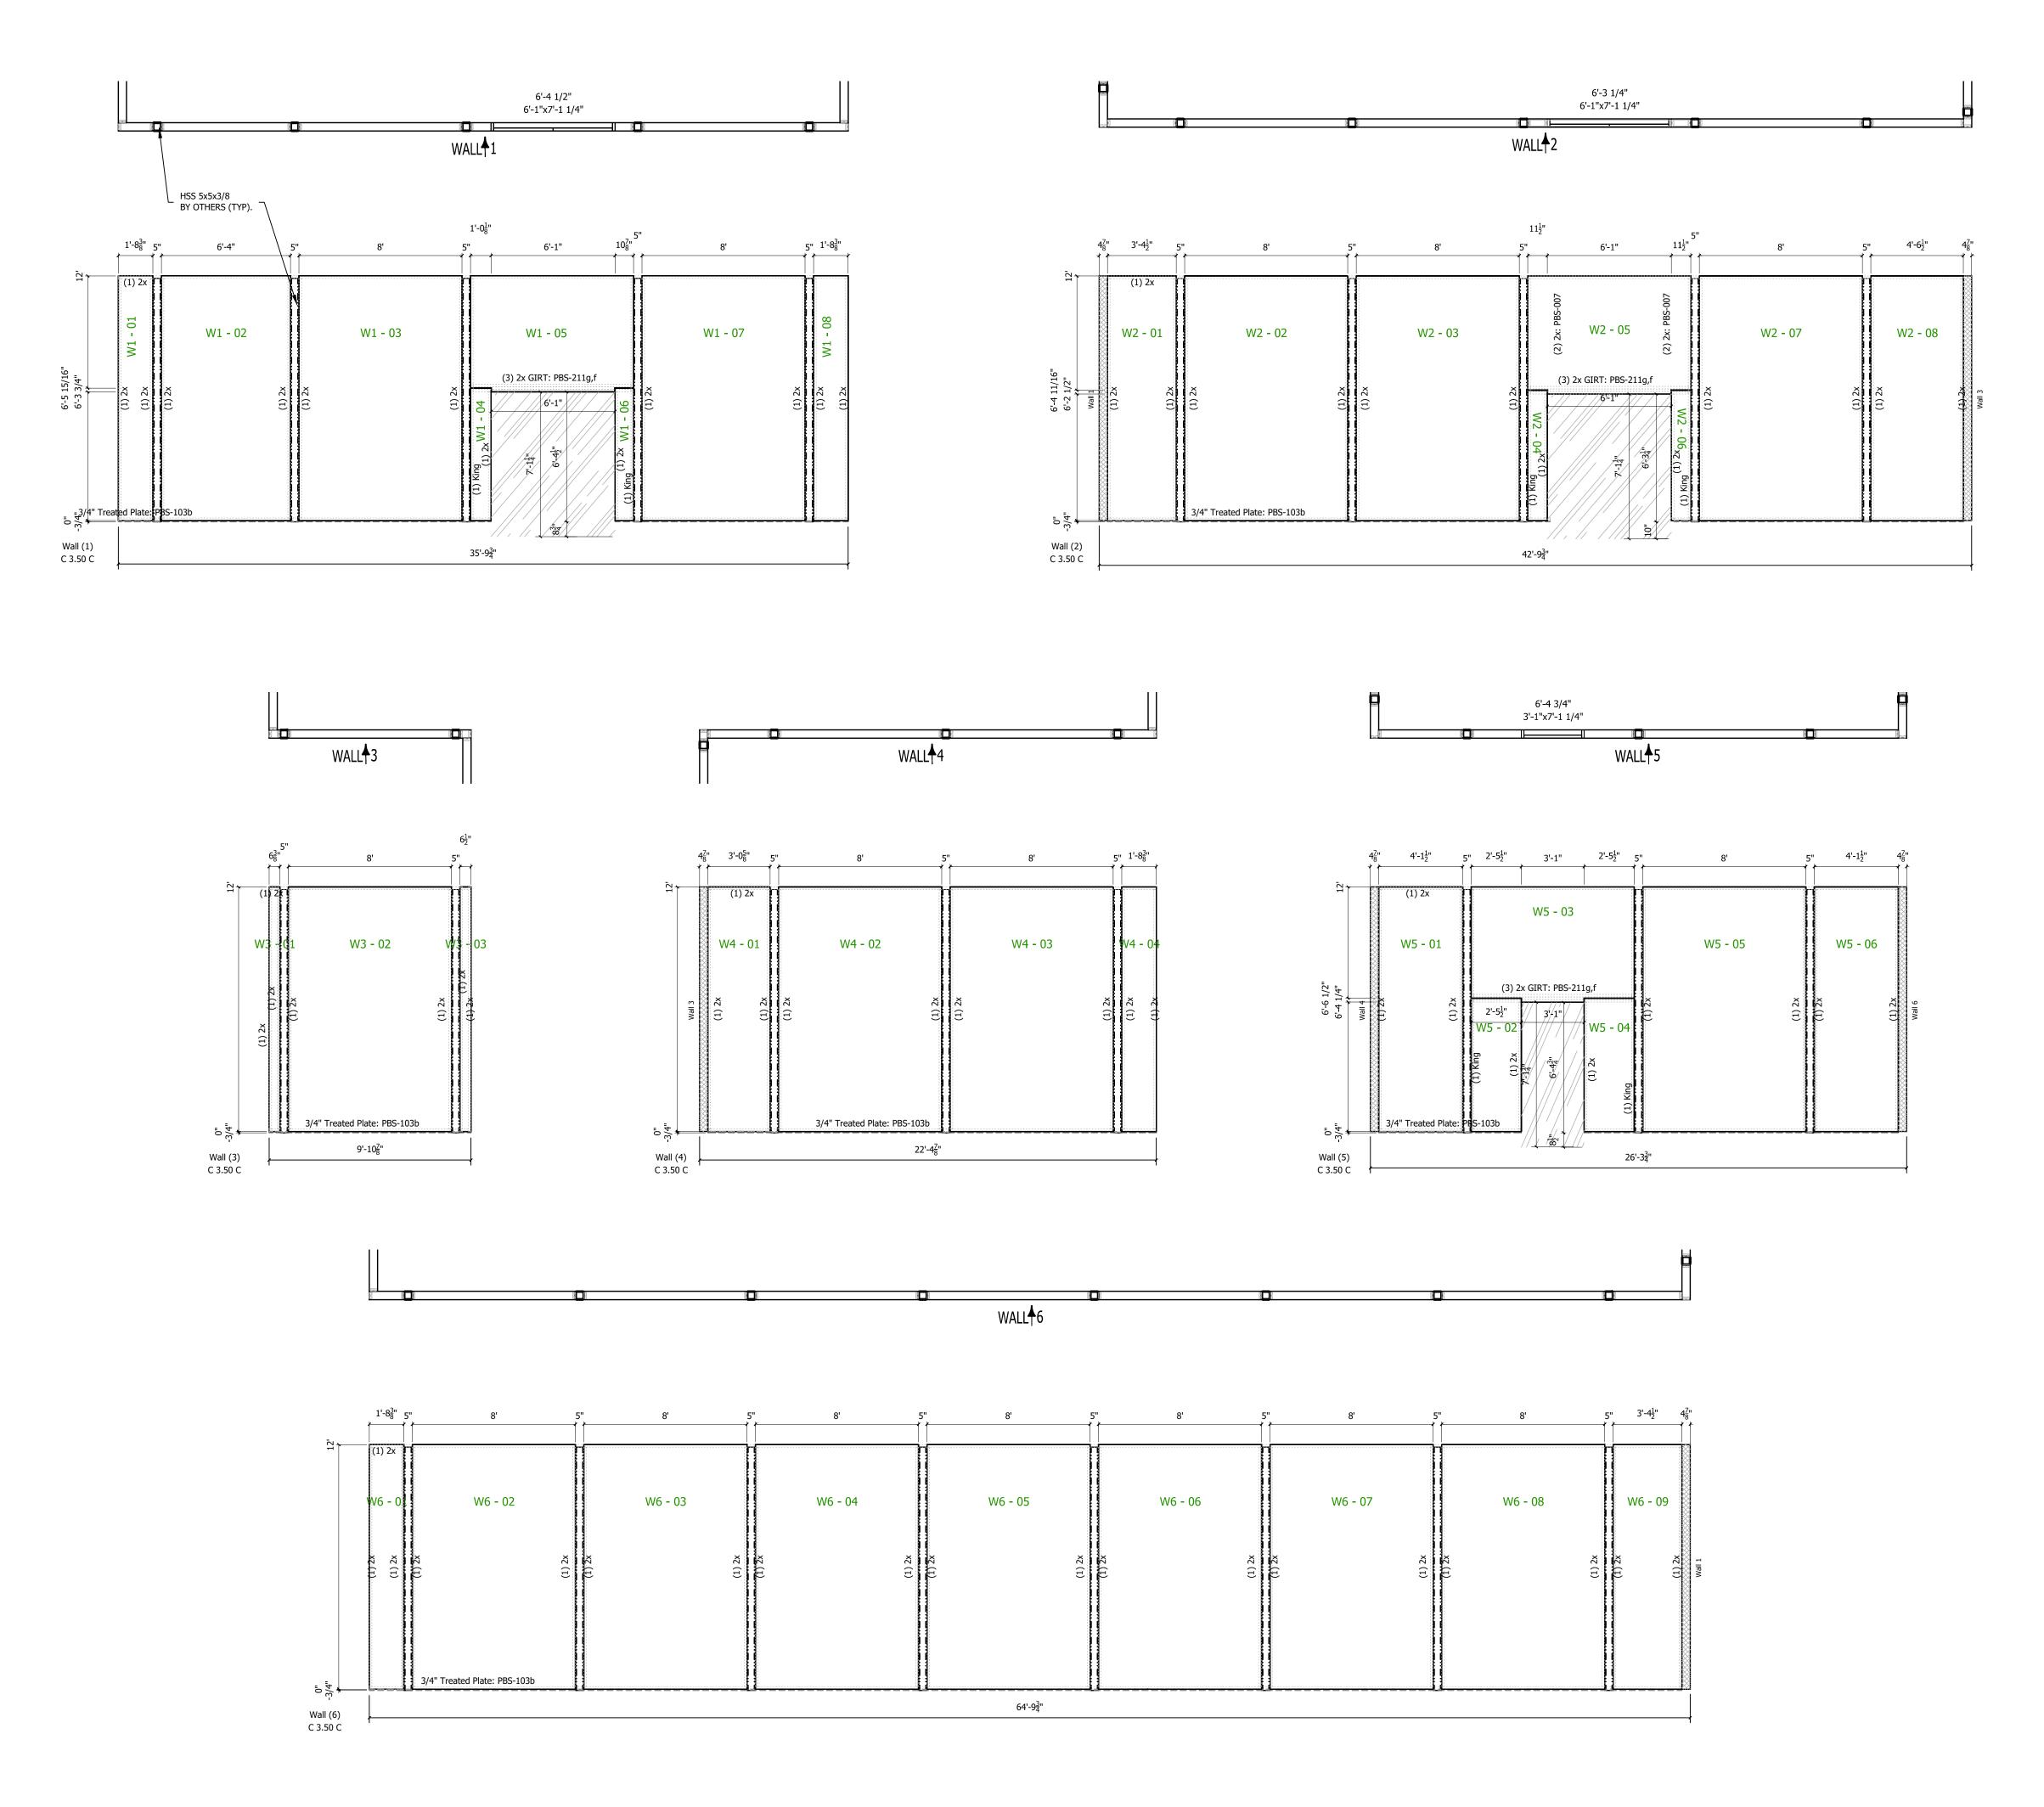

Panel Wall Layouts
4 7/8" Panels

1/4" = 1'-0"

PREMIER MER STRUCTURAL INSULATED PANELS

18504 Canyon Rd. E. Puyallup, Wa 98375 800-275-7086


REVISIONS:		
DRAFTER	DATE	TYPE
RKS	06/04/20	C-REV
RKS	07/15/20	C-REV
RKS	02/53/20	E-REV
RK	02/30/2020	FINAL
	ISIONS: DRAFTER RKS RKS RKS RKS RKS	

PANEL LAYOUTS

CUSTOMER APPROVAL:
AS A SUPPLIER OF MATERIALS, PREMIER BUILDING SYSTEMS DOES NOT ASSUME RESPONSIBILITY FOR ERRORS IN DESIGN,
ENGINEERING, OR DIMENSIONS. OWNER/AGENT (ARCHITECT, CONTRACTOR, AND/OR INSTALLER) SHALL VERIFY ALL
DIMENSIONS AND SIZES AND BY SIGNING THESE PLANS, THE OWNER TAKES FULL RESPONSIBILITY FOR THEIR ACCURACY.
SIGNATURE

C Davis HWQLHC 20200130-0005 iversity of California, Davis

DRAWN: R.STOWERS
CHECKED:
DATE: 04/16/20
SCALE: VARIES
SHEET NO. 3 OF 5

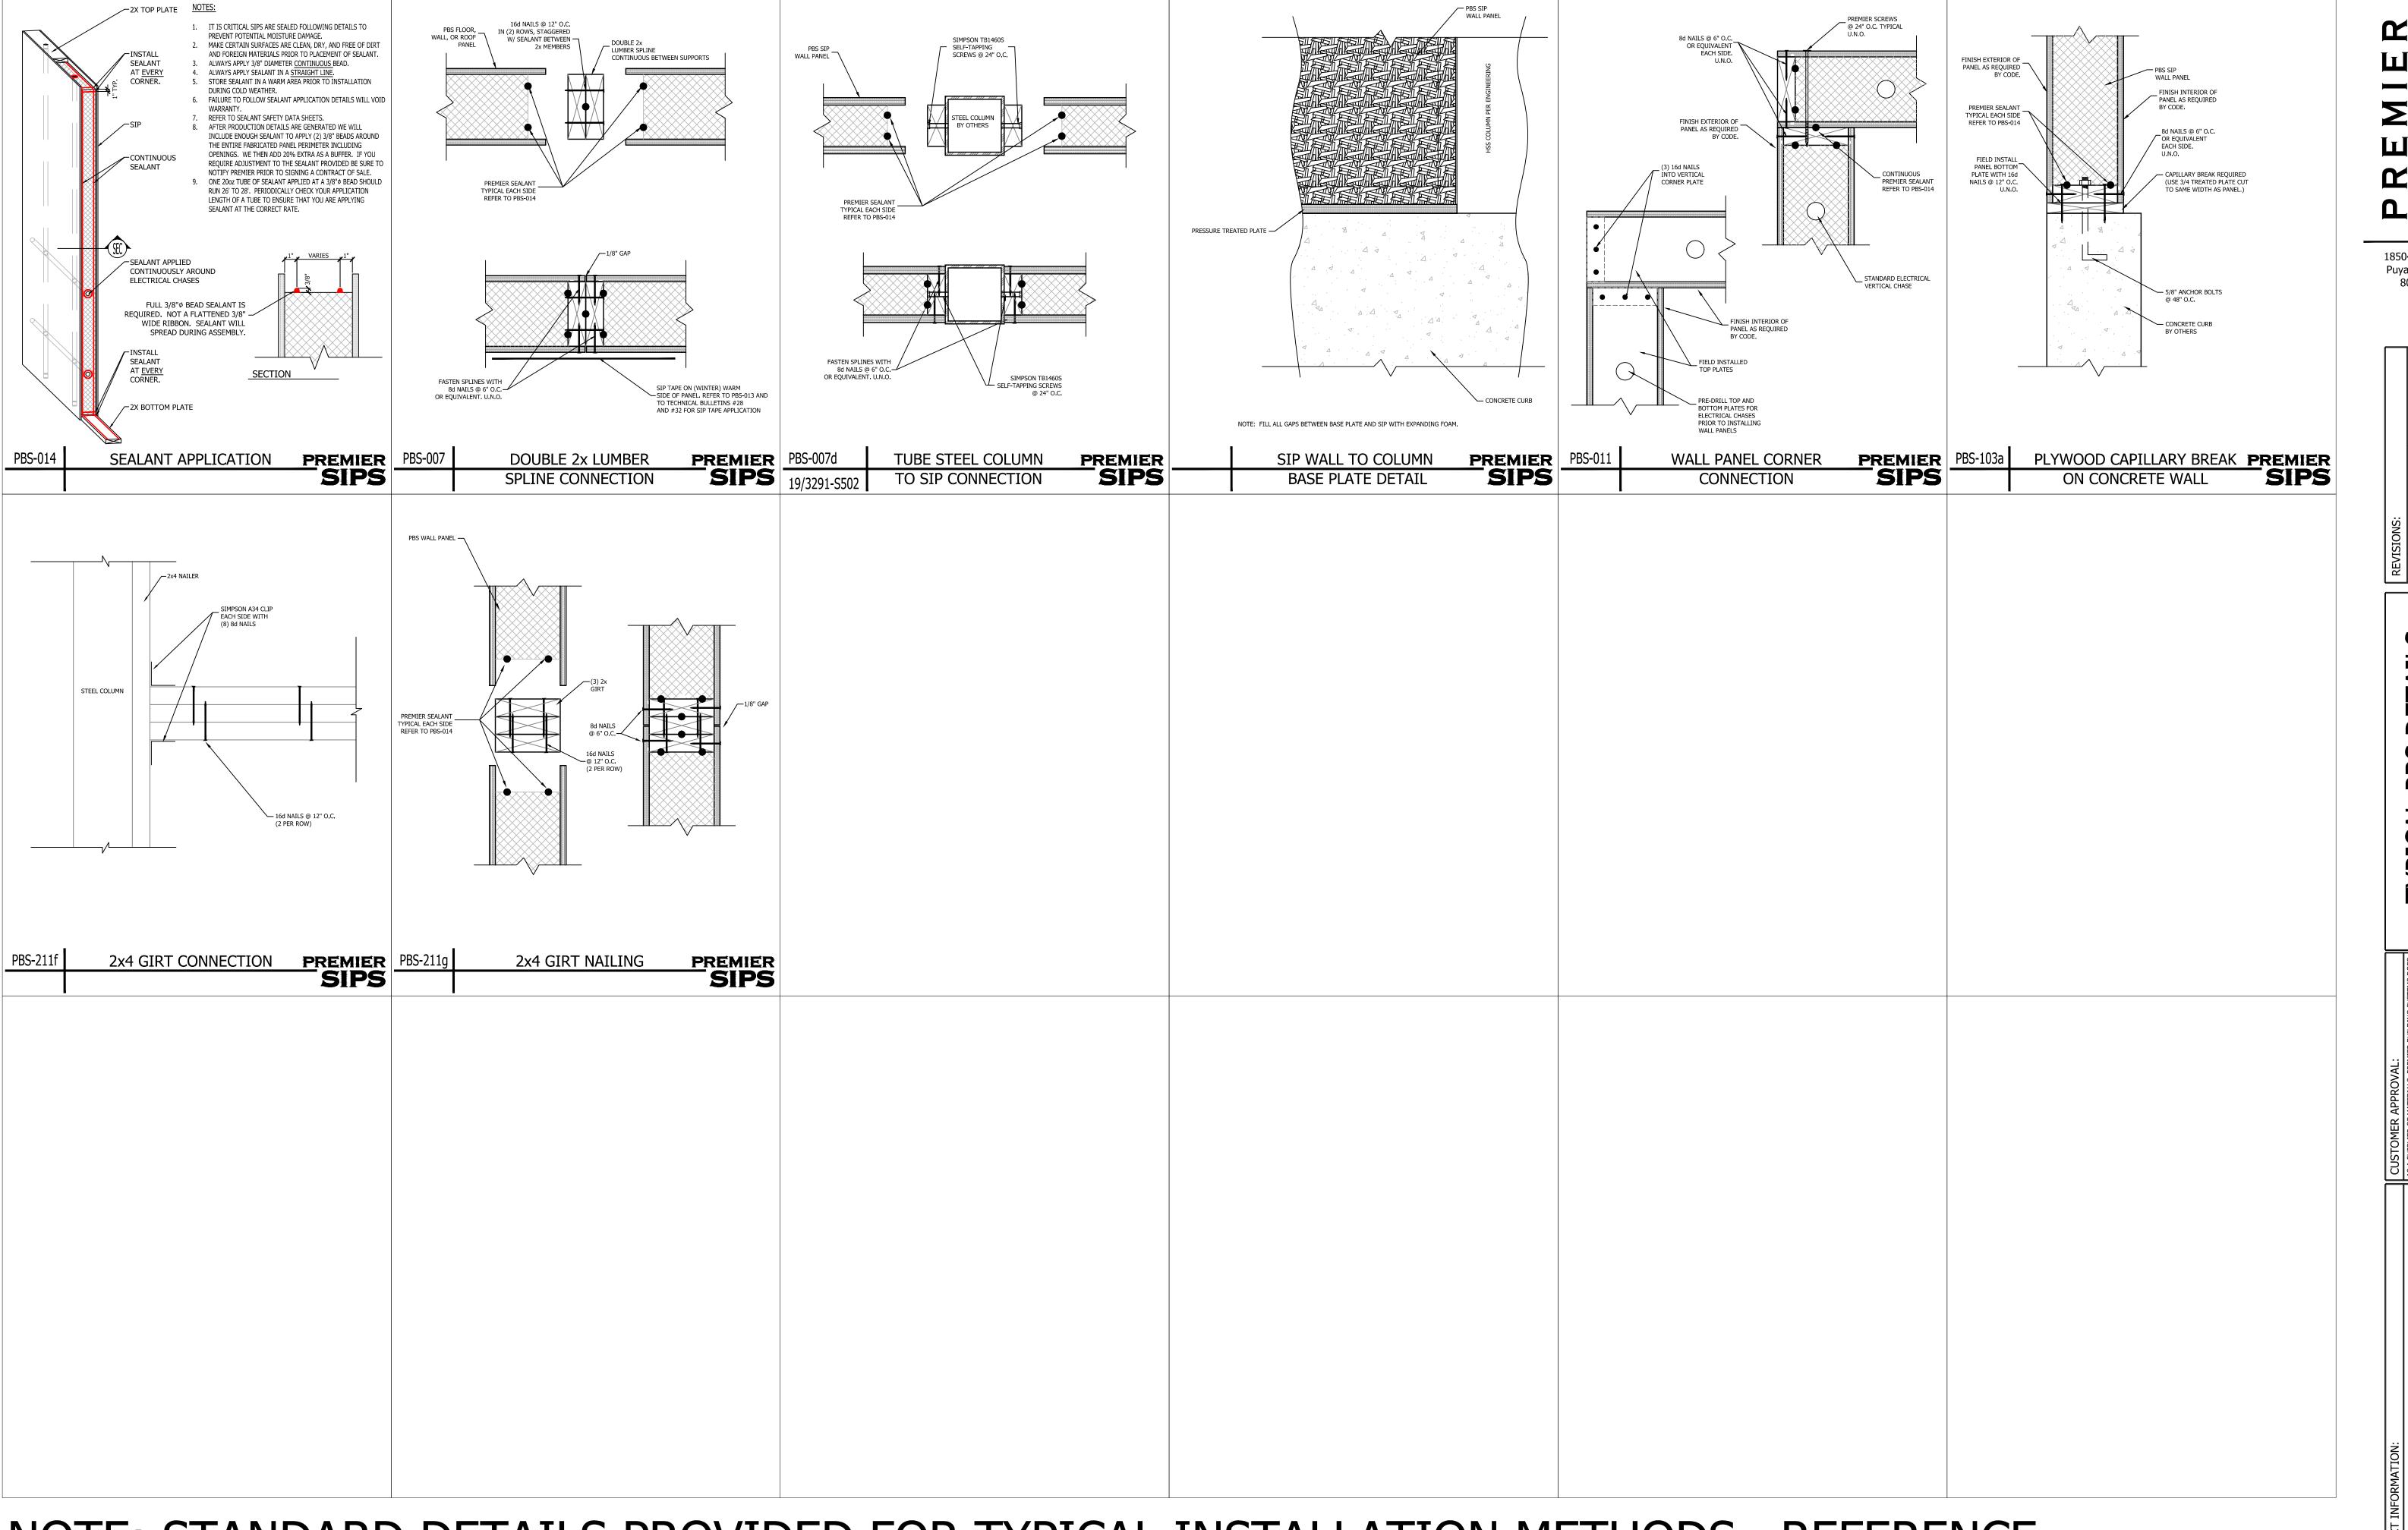



NOTE: STANDARD DETAILS PROVIDED FOR TYPICAL INSTALLATION METHODS. REFERENCE ARCHITECTURAL AND STRUCTURAL DRAWINGS FOR JOB SPECIFIC CONNECTION DETAILS, WHICH TAKE PRECEDENT OVER THESE DETAILS.




RFV	REVISIONS:		
-	10101		
#	DRAFTER	DATE	TYPE
1.	RKS	06/04/20	C-REV
2.	RKS	07/15/20	C-REV
3.	RKS	07/29/20	E-REV
4	RK	07/30/2020	FINAL
5.			

TYPICAL PBS DETAI
OOES

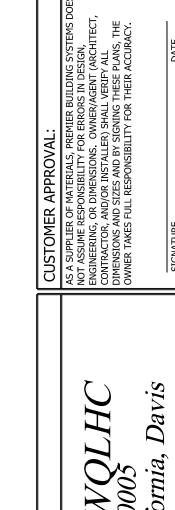

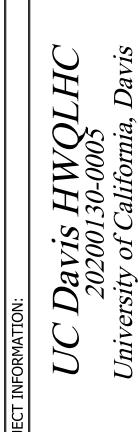

DRAWN: R.STOWERS
CHECKED:
DATE: 04/16/20
SCALE: VARIES
SHEET
NO.

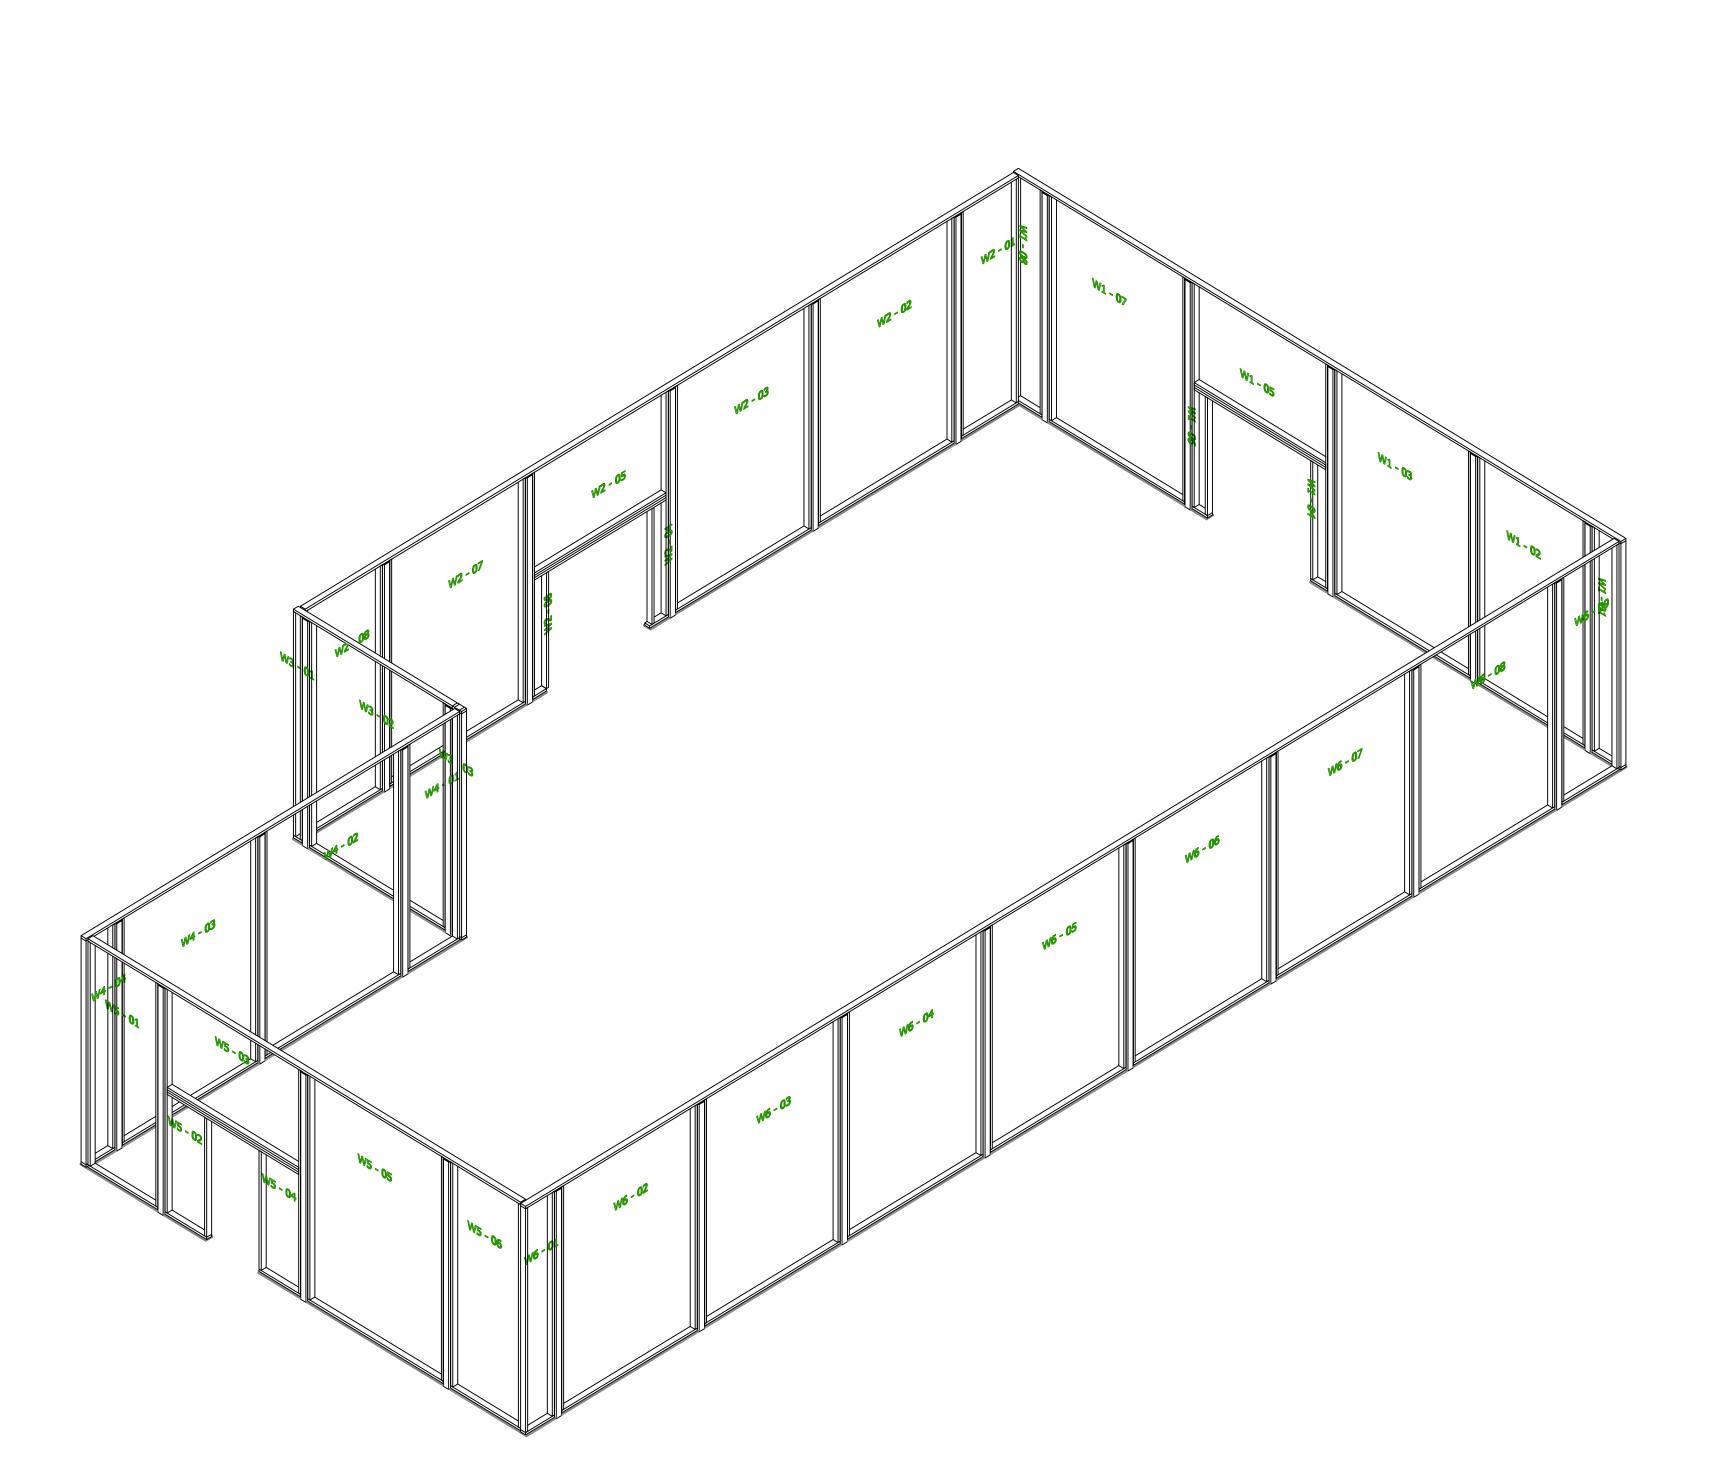

SIP Framing Items
(Items Part of a SIP Wall or Roof)

SIP Framing Items

ITEMS SUPPLIED BY PREMIER ITEMS NOT SUPPLIED BY PREMIER

204 FT Pressure treated plate: 0.75"x4.875"

@ Various Lengths + 10%

64 EA Lumber: 2x4x12'

545 FT Lumber: 2x4 @ Various Lengths + 10%

P FRAMING ITEMS:

THIS IS A LIST OF FRAMING ITEMS PART OF A SIP; BASICALLY ANY LUMBER ITEMS INSTALLED WITHIN A SIP AS WELL AS ANY CAP AND SILL PLATES THAT ARE INSTALLED DIRECTLY ON TOP OF OR JUST BELOW A SIP WALL. ALL PLATE MATERIAL (TOP AND BOTTOM HORIZONTAL PIECES IN SIP WALLS & SUB-FASCIA IN SIP ROOFS) AS WELL AS ANY CUT LENGTHS LESS THAN OR EQUAL TO 9'-0" ARE ADDED UP USING THE FT (LINEAL FOOT) UNIT OF MEASURE. ANY PIECES OVER 9'-0" ARE QUANTIFIED USING THE EA (EACH) UNIT OF MEASURE (I.E. A 2X6 CORNER STUD CUT TO 11'-3" WOULD ADDED TO THE LIST AS (1) 2X6X12'). PLEASE KEEP IN MIND THAT UNLESS NOTED OTHERWISE THIS LIST IS EXACT AND THAT YOU WILL NEED TO ADD ADDITIONAL MATERIAL TO COMPENSATE FOR YIELD LOSS THAT OCCURS IN THE FIELD AS YOU CUT MATERIAL. THIS LIST IS INFORMATIVE ONLY AND PREMIER IS NOT RESPONSIBLE FOR ANY INACCURACIES WHATSOEVER.