

PERMIT SET

REVISIONS

STAMP



PROJECT TITLE

**PARELLA
DISPLAY BARN**

714 DEAL ROAD
ROMULUS, NY

PROJECT NUMBER: 2316

ISSUE DATE: 04.17.2024

DRAWN BY: KS2 / K2


CHECKED BY: AY

SHEET TITLE

FLOOR PLANS

SHEET NUMBER


A-101

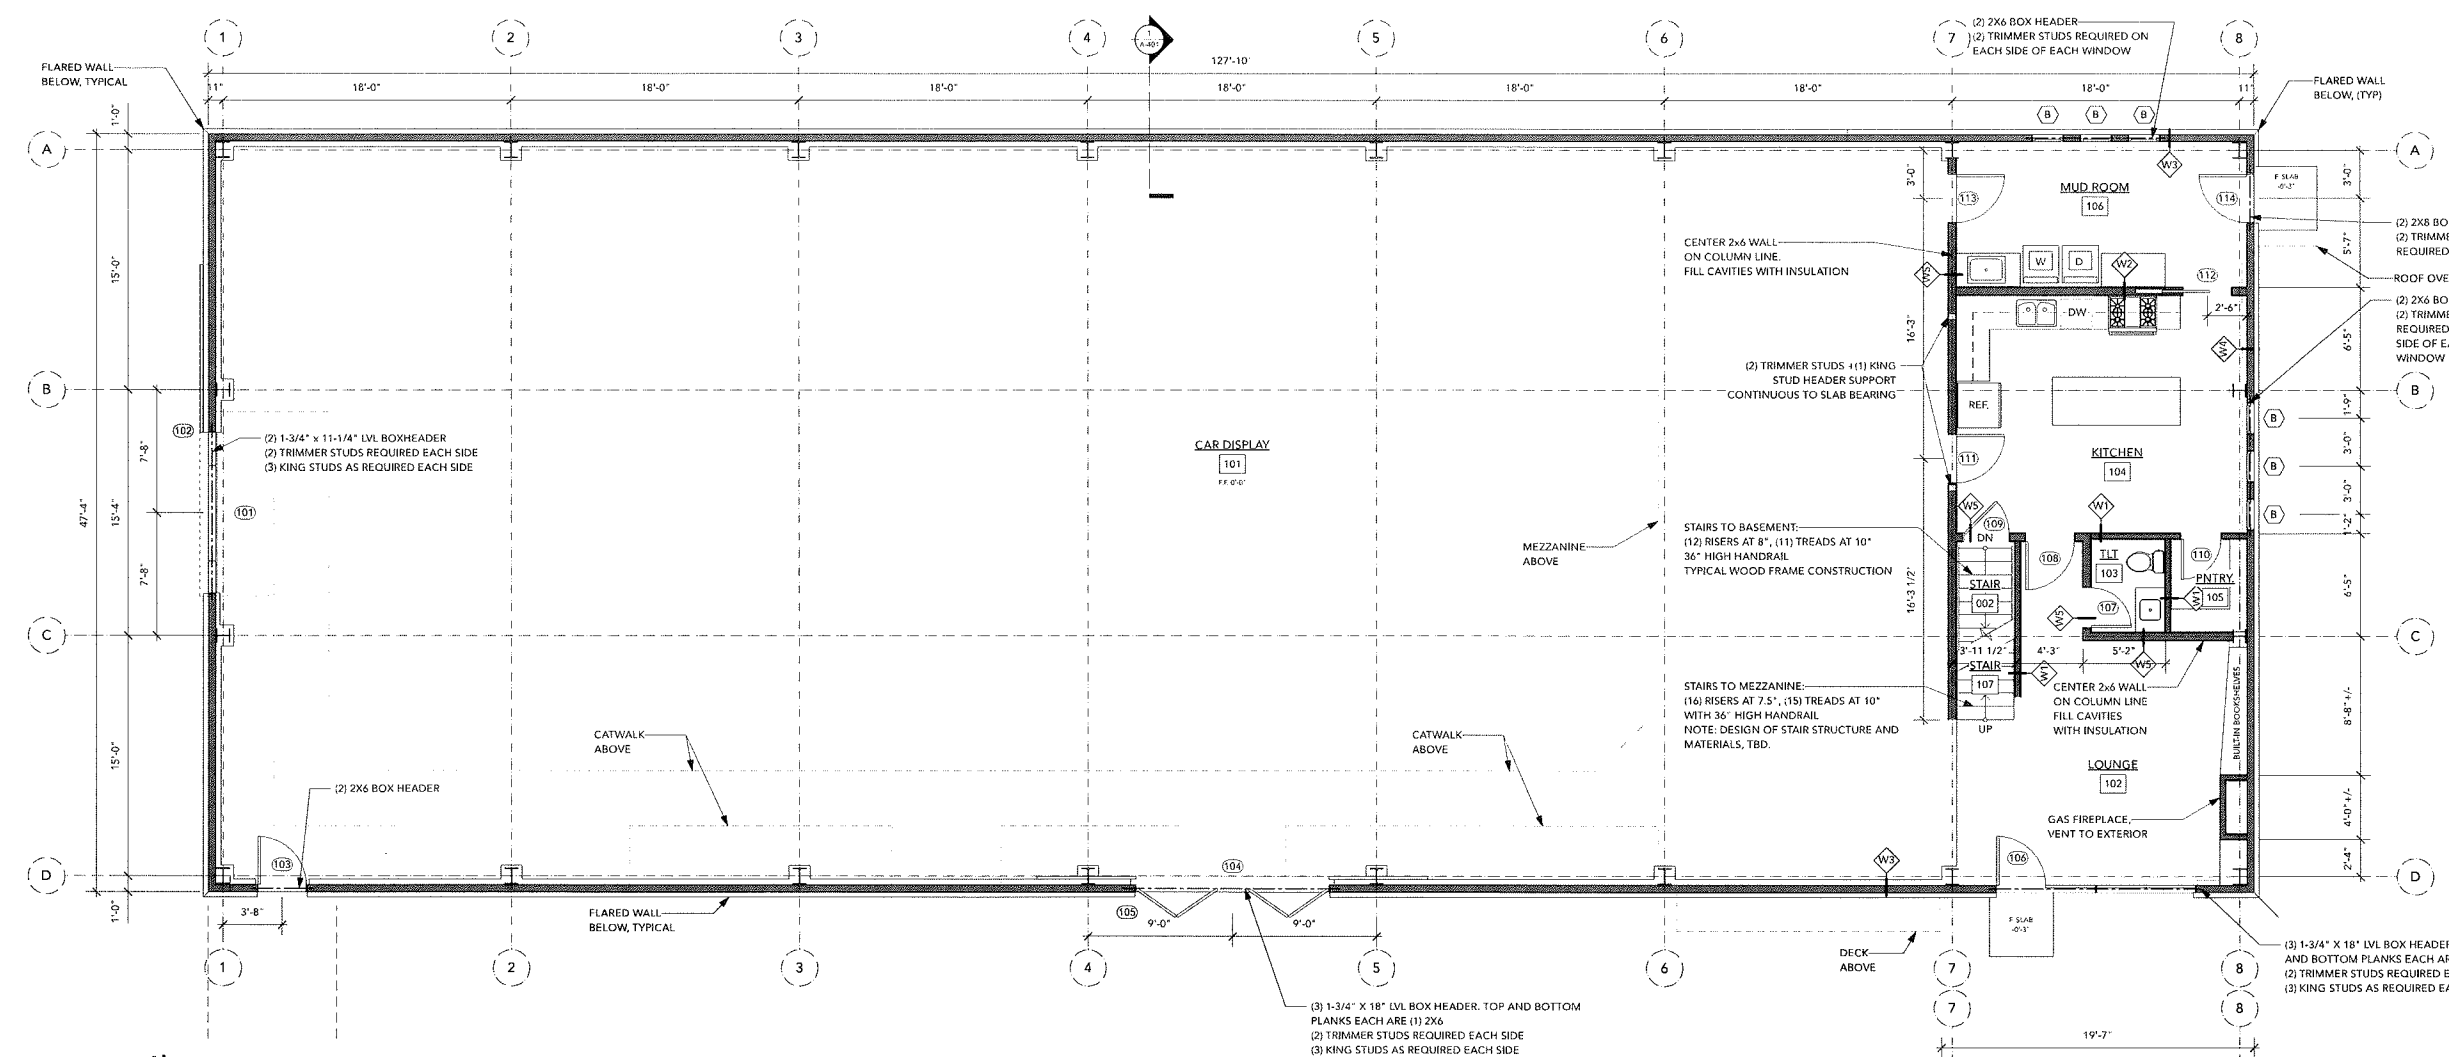


2 FIRST FLOOR PLAN
Scale: 3/16" = 1'-0"

TYPICAL HEADER NOTES:
1. (1) TRIMMER STUD AND (1) KING STUD REQUIRED ON EACH SIDE OF OPENING UNLESS NOTED OTHERWISE.
2. REFER TO DETAILS 6 AND 7 ON SHEET S-106 FOR CONNECTOR CLIPS AT EACH WINDOW AND DOOR OPENING.

LEGEND	
FRAMED CONSTRUCTION	
DOOR W/ DOOR TAG REFER TO WINDOW SCHEDULE FOR ADDITIONAL INFO	
WINDOW TAG REFER TO WINDOW SCHEDULE FOR ADDITIONAL INFO	
ROOM NUMBER SEE ROOM FINISH SCHEDULE FOR ADDITIONAL INFO	
ELEVATION REFERENCE	
DETAIL / SECTION REFERENCE DETAIL NUMBER (TOP) SHEET NUMBER (BOTTOM)	
INTERIOR ELEVATION REFERENCE	

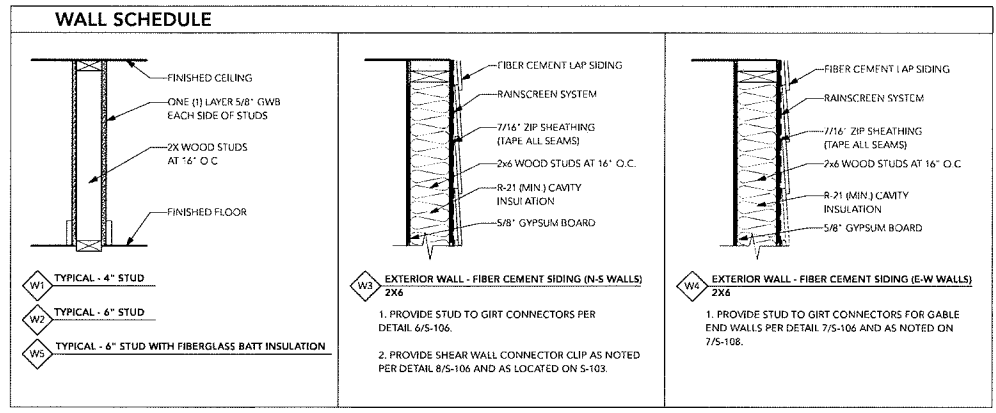

1 BASEMENT FLOOR PLAN
Scale: 3/16" = 1'-0"

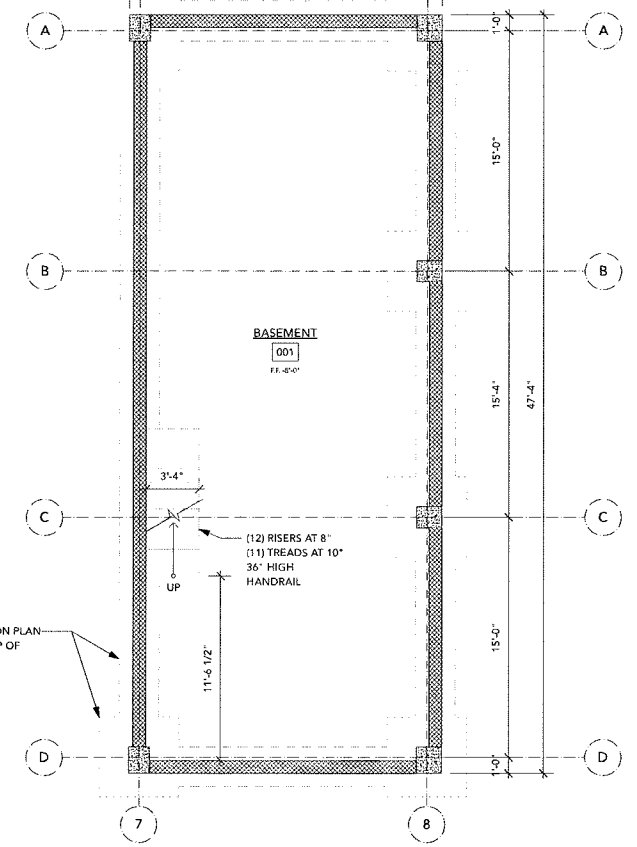

This document and the content represented herein is the copyright property of In-Site Architecture LLP and may not be reproduced or replicated without prior written consent of In-Site Architecture, LLP.

PERMIT SET

REVISIONS

STAMP



PROJECT TITLE

**PARELLA
DISPLAY BARN**

714 DEAL ROAD
ROMULUS, NY

PROJECT NUMBER: 2316

ISSUE DATE: 04.17.2024

DRAWN BY: KS2 / K2

CHECKED BY: AY

SHEET TITLE

FLOOR PLANS

SHEET NUMBER

A-102

GENERAL ROOF NOTES:




1. CONFIRM ALL HEIGHT, NOTES AND DIMENSIONS CONCERNING ROOF FRAMING, SIP PANELS AND RELATED WORK PRIOR TO CONSTRUCTION.
2. PROVIDE ALL FLASHING, COUNTERFLASHING, AND NECESSARY TIE-INS TO PROVIDE A COMPLETE AND WATERTIGHT ROOFING SYSTEM.
3. ROOF VENTING, PIPING AND ALL ROOF PENETRATIONS TO BE COORDINATED AND ALIGNED TO MINIMIZE PENETRATIONS AND VISUAL DISORDER.
4. COORDINATE ROOF DRAIN LOCATIONS WITH CORRESPONDING EXTERIOR ELEVATIONS.
5. PROVIDE MIN 3'-0" ICE AND WATER SHIELD AT ALL EAVES, VALLEYS, RIDGES, CRICKETS, AND RAIN DIVERSERS. DOUBLE LAYER ICE AND WATER SHIELD AS REQUIRED BY CODE AND AS INDICATED.
6. ALL ROOFING SYSTEMS, MATERIALS AND COMPONENTS TO BE INSTALLED PER MANUFACTURER'S REQUIREMENTS.

LAKE LOOKOUT PLAN

- Scale: 3/16" = 1'-0"
- TYPICAL HEADER NOTES:**
1. (1) TRIMMER STUD AND (1) KING STUD REQUIRED ON EACH SIDE OF OPENING UNLESS NOTED OTHERWISE.
 2. REFER TO DETAILS 6 AND 7 ON SHEET 5-106 FOR CONNECTOR CLIPS AT EACH WINDOW AND DOOR OPENING.

ROOF PLAN

Scale: 1/8" = 1'-0"

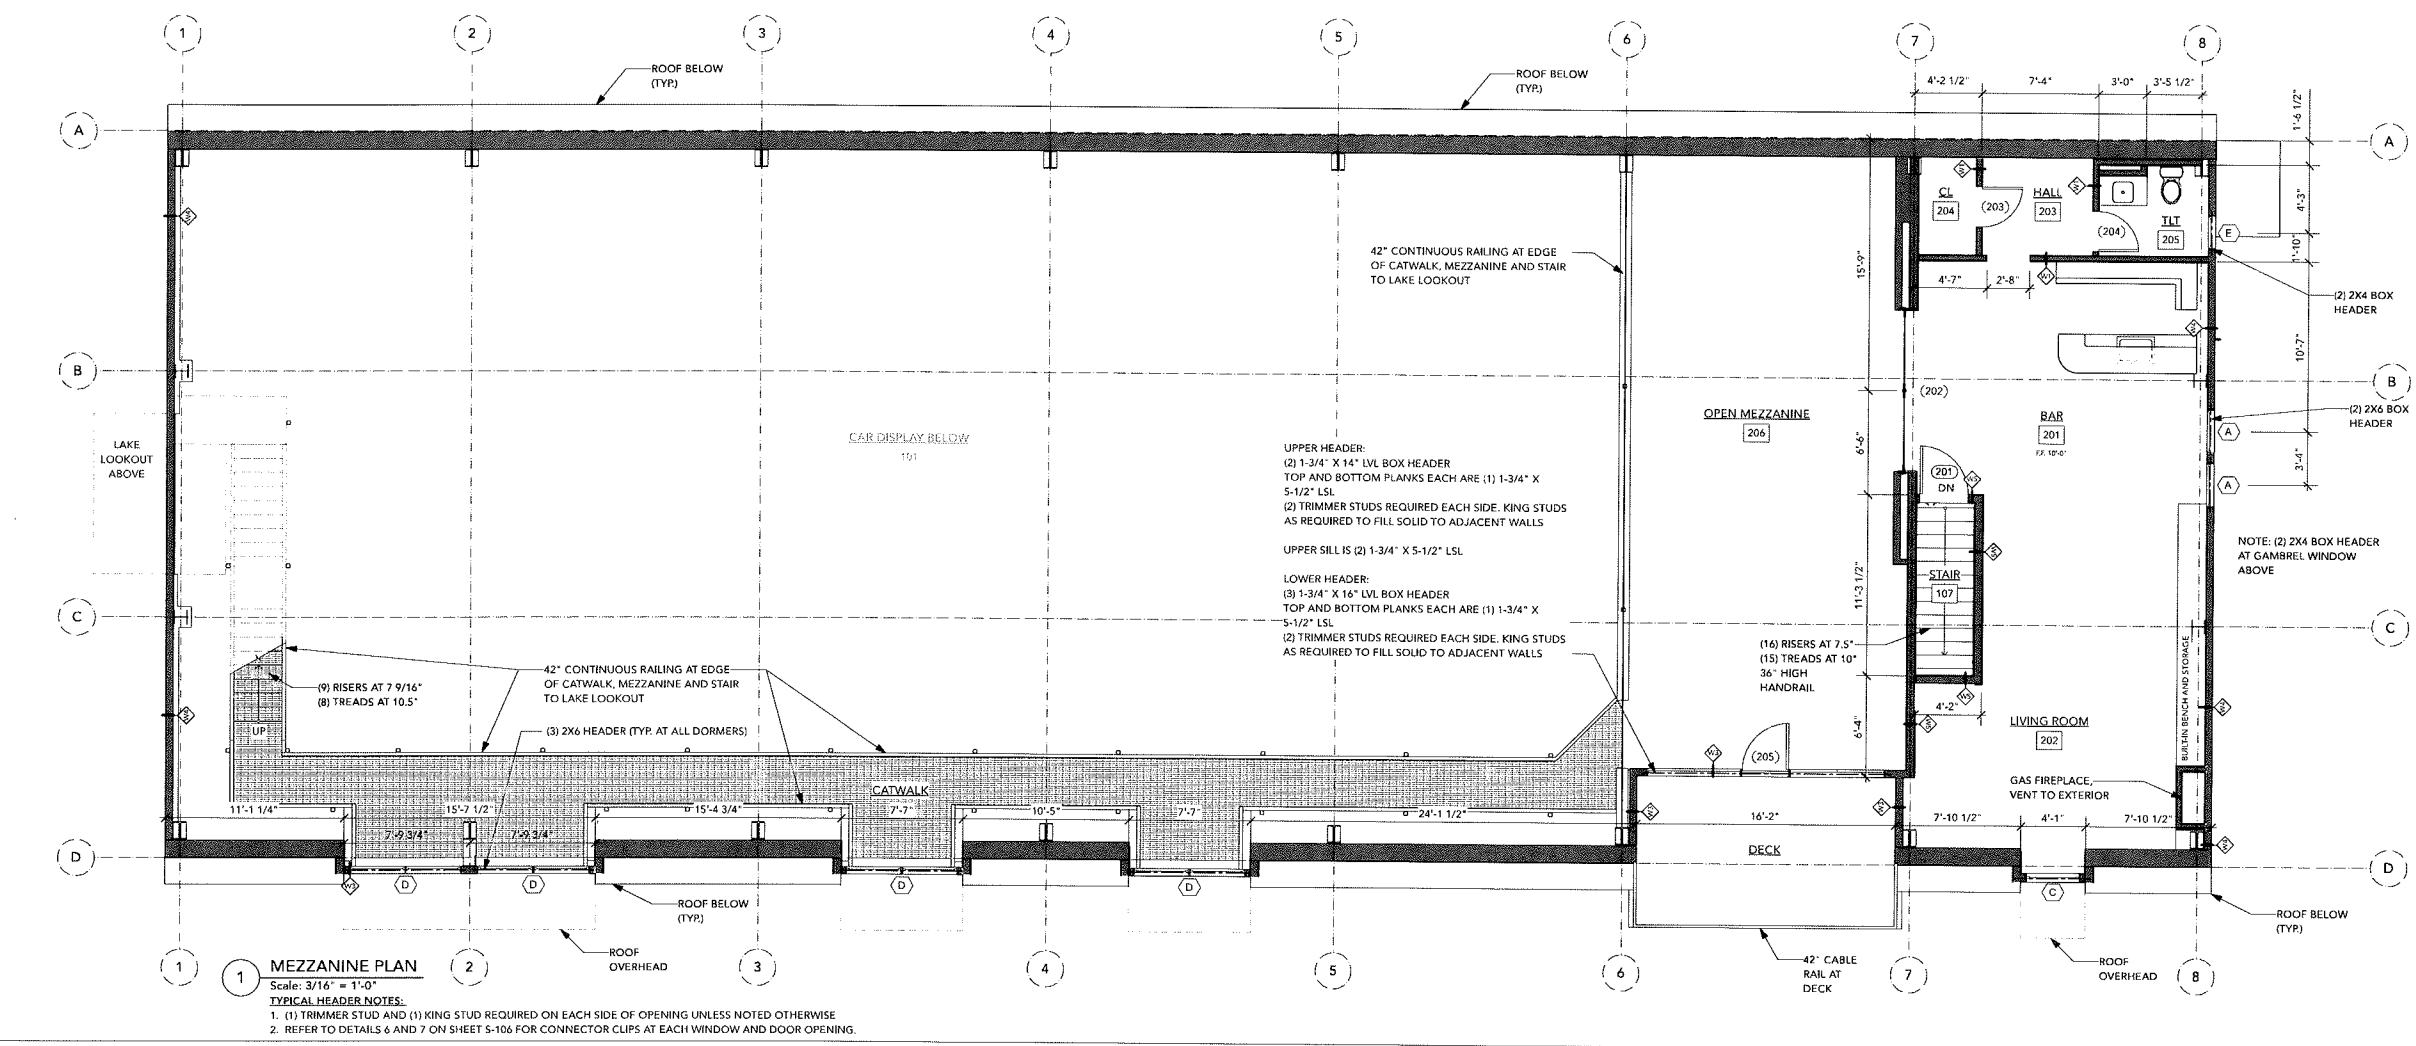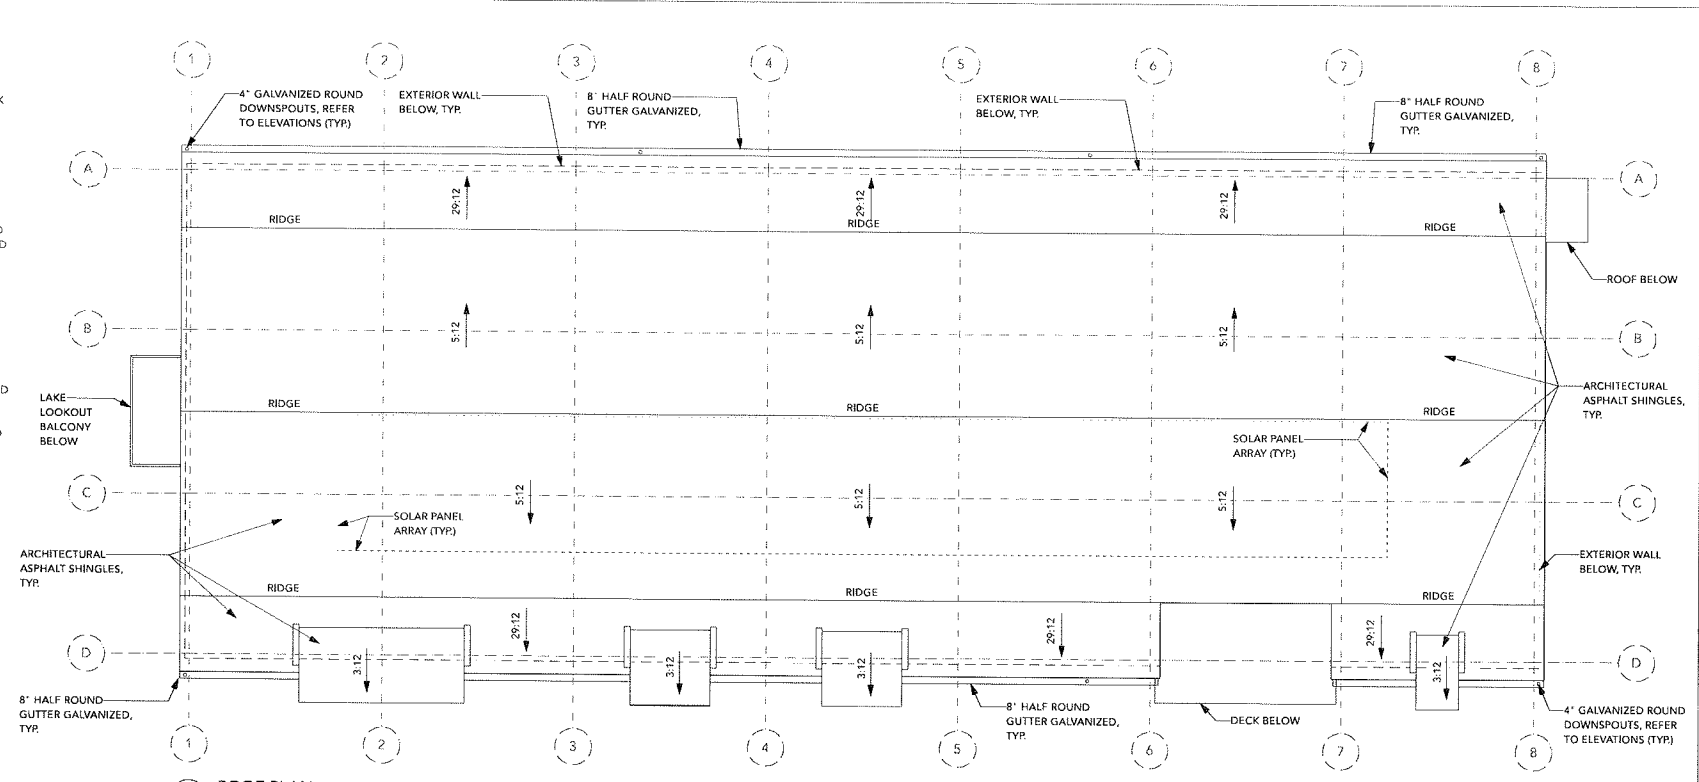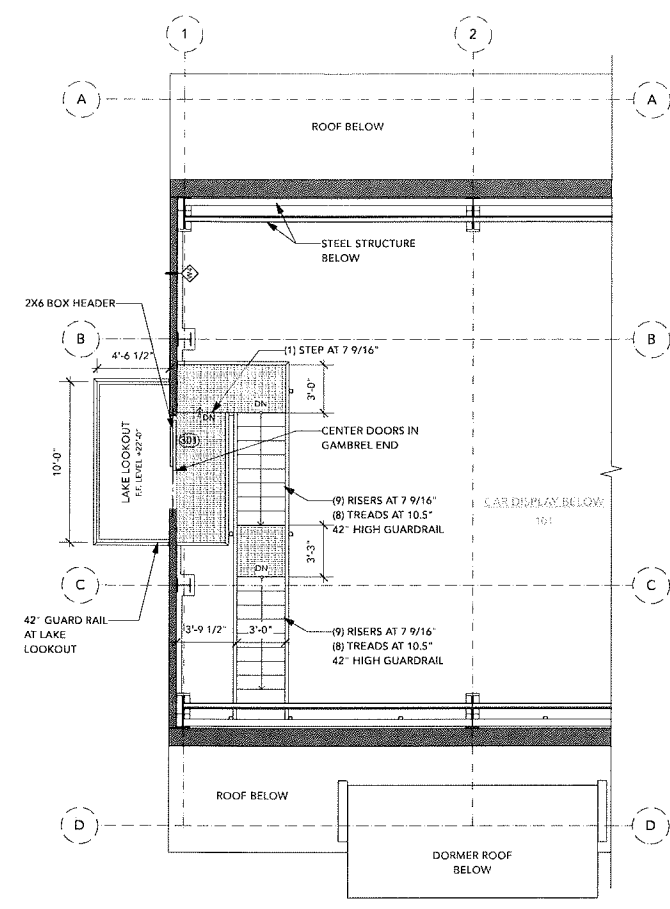

MEZZANINE PLAN

Scale: 3/16" = 1'-0"

TYPICAL HEADER NOTES:

1. (1) TRIMMER STUD AND (1) KING STUD REQUIRED ON EACH SIDE OF OPENING UNLESS NOTED OTHERWISE.
2. REFER TO DETAILS 6 AND 7 ON SHEET 5-106 FOR CONNECTOR CLIPS AT EACH WINDOW AND DOOR OPENING.

This document and the content represented herein is the copyrighted property of In-Site-Architecture, L.P. and may not be reproduced or replicated without prior written consent of In-Site-Architecture, L.P.