# ERICKSON RESIDENCE

# 23359 Oldfield Ave N Scandia, MN 55073

A.C.T. ACOUSTICAL CEILING TILE FIN. FINISH (ED) O.C. ON CENTER
ADJ. ADJUSTABLE A.F. ABOVE FINISHED FLOOR F.O.C. FACE OF CONCRETE ALUM. ALUMINUM F.O.M. FACE OF MASONRY REF. REFER, REFERENCE ALT. ALTERNATE B.D. BOARD BLDG. BUILDING BUILDING BOTTOM B

	DRAWING SCHEDULE
Sheet Number	Sheet Name
A001	TITLE SHEET/SITE PLAN
A101	FOUNDATION PLAN & DETAILS
A102	MAIN FLOOR PLAN
A103	ROOF PLAN
A104	EXTERIOR ELEVATIONS
A105	EXTERIOR ELEVATIONS
A106	BUILDING SECTIONS

APPLICABLE ZONING CODE:	CITY OF SCANDIA MN ZONING REGULATIONS (CHAPTER 2)	
CURRENT ZONING:	AGRICULTURE - CORE (AG C)	
TOTAL SITE AREA:	39.82 ACRES	
PIN:	0203220320001	
SITE ADDRESS:	23359 OLDFIELD AVE N SCANDIA, MN 55073	
WATERSHED DISTRICT:	WS COMFORT LAKE - FOREST LAKE	

#### SITE PLAN GENERAL NOTES

- 1. THE ARCHITECT SHALL HAVE NO RESPONSIBILITY FOR THE DISCOVERY, PRESENCE, HANDLING, REMOVAL, DISPOSAL, OR EXPOSURE OF PEOPLE TO HAZARDOUS MATERIALS IN ANY FORM, INCLUDING, BUT NOT LIMITED TO, ASBESTOS PRODUCTS, POLYCHLORINATED BIPHENYL (PCB) OR OTHER TOXIC SUBSTANCES.
- 2. CONTRACTOR SHALL PROVIDE WRITTEN NOTICE OF ANY CHANGES THAT INVOLVE ADDITIONAL COST AND/OR TIME TO THE ARCHITECT AND OWNER WITHIN FIVE DAYS OF ITS DISCOVERY AND BEFORE PROCEEDING WITH
- 3. ALL WORK PERFORMED BY THE CONTRACTOR AND SUBCONTRACTORS, INCLUDING MATERIALS AND LABOR SHALL BE GUARANTEED IN WRITING
- 4. GENERAL CONTRACTOR AND SUBCONTRACTORS SHALL LEAVE THE SITE CLEAN AND FREE OF DEBRIS RELATED TO THEIR WORK DAILY.

FOR ONE YEAR FROM DATE OF OCCUPANCY.

- 5. SUBCONTRACTORS ARE RESPONSIBLE FOR MEANS AND METHODS FOR INSTALLATION OF WORK INDICATED ON THESE DRAWINGS, COORDINATED THROUGH THE GENERAL CONTRACTOR.
- SPOT ELEVATIONS OF GRADES SHOWN ARE APPROXIMATE. VERIFY
  EXACT CONDITIONS OF EXISTING GRADING IN THE FIELD.
   LANDSCAPING (HARDSCAPE AND SOFTSCAPE) SHOWN ON PLAN IS OF
  GENERAL INTENT. LANDSCAPE CONTRACTOR TO VERIFY EXISTING FIELD
  CONDITIONS AND FOR INTENT TO BE MET AS BEST FIT AND TO TIE IN
- WITH EXISTING SITE CONDITIONS.

  8. COMPOSITE DECK POSTS TO BE SPACED EQUALLY ALONG DECK AT EACH DIMENSION SHOWN (6'-0" MAXIMUM CENTERLINE TO CENTERLINE).
- 9. THE ARCHITECT HAS NO KNOWLEDGE OF AND SHAL NOT BE HELD LIABLE IF ANY ASBESTOS, LEAD BASED PAINT AND/OR OTHER HAZARDOUS MATERIALS ARE DISCOVERED DURING CONSTRUCTION. THE CONTRACTOR SHALL ISOLATE THE AFFECTED AREA/MATERIALS AND CONTACT THE OWENR FOR FURTHER INSTRUCTIONS BEFORE PROCEEDING.

### PROJECT NOTES

#### **GENERAL NOTES:**

- ITEMS LISTED BELOW ARE APPLICABLE TO ALL CONTRACTORS,
  SUBCONTRACTORS, VENDORS, SUPPLIERS AND MATERIAL HANDLERS.
  THE CONTRACT DOCUMENTS, SUPPLIERS AND MATERIAL HANDLERS.
  THE CONTRACT DOCUMENTS OF THE CONTRACT DOCUMENTS AS
- MODIFICATIONS AND THE CONDITIONS OF THE CONSTRUCTION CONTRACT

  THE CONTRACT DOCUMENTS ARE THE INSTRUMENTS OF SERVICE AND
  SHALL REMAIN THE PROPERTY OF THE ARCHITECT WHETHER THE
  PROJECT FOR WHICH THEY ARE PREPARED IS EXECUTED OR NOT. THE
  CONTRACT DOCUMENTS ARE NOT TO BE USED FOR OTHER PROJECTS OR
  EXTENSION TO THE PROJECT NOR ARE THEY TO BE MODIFIED IN ANY
  MANNER WHATSOEVER EXCEPT BY AGREEMENT IN WRITING AND WITH
- APPROPRIATE COMPENSATION TO THE ARCHITECT.
   STANDARD FORM OF AGREEMENT BETWEEN OWNER AND CONTRACTOR AIA DOCUMENT A105 SHALL BE MADE PART OF THESE DOCUMENTS BY
- ALL WORK SHALL COMPLY WITH THE APPLICABLE CODES, AMENDMENTS, RULES, REGULATIONS, ORDINANCES, LAWS, ORDERS, APPROVALS, ETC. THAT ARE REQUIRED BY PUBLIC AUTHORITIES. IN THE EVENT OF CONFLICT, THE MOST STRINGENT REQUIREMENTS SHALL COMPLY. REQUIREMENTS INCLUDE, BUT ARE NOT LIMITED TO THE CURRENT APPLICABLE EDITIONS OR PUBLICATIONS.
- RUST ARCHITECTS, P.A. RELIES UPON THE PROFESSIONALISM AND ACCURACY OF WORK DESIGNED BY OTHER SUBCONTRACTORS AND RELIES THAT THE SYSTEMS DESIGNED BY OTHERS WILL PERFORM AS REQUIRED AND PER INDUSTRY STANDARD.

## CONTRACT DOCUMENT NOTES:

- THIS SET OF DOCUMENTS IS NOT ALL INCLUSIVE AND IS MEANT TO SHOW THE INTENT OF THE SCOPE OF WORK, THE CONTRACTOR SHALL BID ALL WORK INVOLVED WITH A NORMALLY ANTICIPATE SCOPE OF WORK.

  ALL SHEETS LISTED IN THE DRAWING INDEX COMPRISE THE CONSTRUCTION DOCUMENTS FOR THIS PROJECT. THE CONTRACTOR IS
- RESPONSIBLE FOR ALL THE WORK DEFINED IN THESE CONSTRUCTION DOCUMENTS INCLUDING DISTRIBUTING DRAWINGS TO SUB-CONTRACTORS FOR BIDDING PURPOSES. IT IS NOT RECOMMENDED THAT INDIVIDUAL SHEETS BE GIVEN TO SUB-CONTRACTORS FOR BIDDING OR CONSTRUCTION. THE ENTIRE SET OF DRAWINGS, NOT ANY INDIVIDUAL SHEETS DEFINE THE
- WORK REQUIRED UNDER THE GENERAL CONTRACT.

  IN THE EVENT OF CONFLICT BETWEEN DATA SHOWN ON DRAWINGS AND DATA SHOWN IN THE SPECIFICATIONS, THE SPECIFICATIONS SHALL GOVERN. DIMENSIONS NOTED ON DRAWINGS SHALL TAKE PRECEDENCE OVER SCALED DIMENSIONS. DETAIL DRAWINGS TAKE PRECEDENCE OVER DRAWINGS OF SMALL SCALE. SHOULD THE CONTRACTOR AT ANY TIME DISCOVER AN ERROR IN A DRAWING OR SPECIFICATION, OR A DISCREPANCY OR VARIATION BETWEEN DIMENSIONS ON DRAWINGS OR OTHER INFORMATION, IT SHALL BE BROUGHT TO THE ARCHITECT'S ATTENTION AND SHALL NOT PROCEED WITH WORK AFFECTED UNTIL CLARIFICATION OR
- RESOLUTION HAS BEEN MADE.
   "SIMILAR" MEANS COMPARABLE CHARACTERISTICS FOR CONDITIONS NOTED.
   CONTRACTOR TO VERIFY DIMENSIONS AND ORIENTATION.
- "TYPICAL" MEANS IDENTICAL FOR CONDITIONS NOTED.
   DO NOT SCALE DRAWINGS, WRITTEN DIMENSIONS GOVERN. VERIFY DIMENSIONS WITH FIELD CONDITIONS PRIOR TO CONSTRUCTION. IF DISCREPANCIES ARE DISCOVERED BETWEEN FIELD CONDITIONS AND DRAWINGS OR BETWEEN INDIVIDUAL DRAWINGS CONTACT ARCHITECT FOR RESOLUTION BEFORE PROCEEDING.
- HORIZONTAL DIMENSIONS INDICATED ARE TO/FROM FINISHED FACE OF CONSTRUCTION EXCEPT AS NOTED.

   VERTICAL DIMENSIONS INDICATED ARE FROM TOP OF FLOOR SLAB/TOPPING
- EXCEPT WHERE NOTED TO BE ABOVE FINISHED FLOOR (A.F.F.).
   DIMENSIONS ARE NOT ADJUSTABLE WITHOUT APPROVAL OF ARCHITECT UNLESS NOTED +/-.
   ALL SYMBOLS AND ABBREVIATIONS USED ON THE DRAWINGS ARE CONSIDERED TO BE CONSTRUCTION STANDARDS. IF THE CONTRACTOR
- HAS QUESTIONS REGARDING SYMBOLS AND ABBREVIATIONS USED OR THEIR EXACT MEANING THE ARCHITECT SHALL BE NOTIFIED FOR CLARIFICATION.
   THERE SHALL BE NO SUBSTITUTION DURING BIDDING OF MATERIALS WHERE A MANUFACTURER IS SPECIFIED. WHERE THE TERM "EQUAL" IS
- THERE SHALL BE NO SUBSTITUTION DURING BIDDING OF MATERIALS WHERE A MANUFACTURER IS SPECIFIED. WHERE THE TERM "EQUAL" IS USED ARCHITECT AND OWNER SHALL DETERMINE EQUALITY BASED UPON INFORMATION AND COSTS SUBMITTED BY CONTRACTOR.

# CONSTRUCTION NOTES:

- ALL CONTRACTORS AND SUB-CONTRACTORS ARE RESPONSIBLE FOR PAYING FOR AND OBTAINING ALL THEIR OWN PERMITS AS MAY BE
- REQUIRED BY GOVERNING AUTHORITIES.
   ALL CONTRACTORS AND SUB-CONTRACTORS ARE RESPONSIBLE FOR OBTAINING ALL THEIR OWN PERMITS AS MAY BE REQUIRED BY GOVERNING AUTHORITIES.
- CONTRACTOR SHALL BE RESPONSIBLE FOR CHECKING CONTRACT DOCUMENTS, FIELD CONDITIONS AND DIMENSIONS FOR ACCURACY AND CONFIRMING THAT WORK IS AS SHOWN BEFORE PROCEEDING WITH CONSTRUCTION. CLARIFICATIONS REGARDING ANY CONFLICTS SHALL BE ACHIEVED PRIOR TO RELATED WORK BEING STARTED.

- CONTRACTOR TO COORDINATE CONSTRUCTION NEEDS FOR PHONE, POWER, DATA, LIGHTING, ETC. WITH OWNER PRIOR TO NEGOTIATING PROJECT COST.
- CONTRACTOR SHALL ORDER AND SCHEDULE DELIVERY OF MATERIALS IN AMPLE TIME TO AVOID DELAYS IN CONSTRUCTION. IF AN ITEM IS FOUND TO BE UNAVAILABLE THE CONTRACTOR SHALL NOTIFY ARCHITECT IMMEDIATELY TO ALLOW A REASONABLE AMOUNT OF TIME TO SELECT AND APPROPRIATE SUBSTITUTE.
- ONLY NEW ITEMS OF RECENT MANUFACTURER, OF STANDARD QUALITY, FREE FROM DEFECTS, WILL BE PERMITTED ON THE WORK. REJECTED ITEMS SHALL BE REMOVED IMMEDIATELY FORM THE WORK AND REPLACED WITH ITEMS OF THE QUALITY SPECIFIED. FAILURE TO REMOVE REJECTED MATERIALS AND EQUIPMENT SHALL NOT RELIEVE THE CONTRACTOR FROM THEIR RESPONSIBILITY FOR QUALITY AND CHARACTER OF ITEMS USED NOR FROM ANY OTHER OBLIGATION
- IMPOSED ON HIM BY THE CONTRACT.

   ALL FINISHED WORK SHALL BE FIRM, WELL ANCHORED, IN TRUE ALIGNMENT, PLUMB, LEVEL, WITH SMOOTH, CLEAN, UNIFORM APPEARANCE WITHOUT WAVES, DISTORTIONS, HOLES, MARKS, CRACKS, STAINS OR DISCOLORATION. JOINTINGS SHALL BE TIGHT FITTING, NEAT AND WELL SCRIBED. THE FINISH WORK SHALL NOT HAVE EXPOSED UNSIGHTLY ANCHORS OR FASTENERS AND SHALL NOT PRESENT HAZARDOUS, UNSAFE CORNERS. ALL WORK SHALL HAVE THE PROVISION FOR EXPANSION, CONTRACTION AND SHRINKAGE AS NECESSARY TO PREVENT CRACKS, BUCKLING AND WARPING DUE TO TEMPERATURE AND
- HUMIDITY CONDITIONS.
  ATTACHMENTS, CONNECTIONS OR FASTENINGS OF ANY NATURE ARE TO BE PROPERLY AND PERMANENTLY SECURED IN CONFORMANCE WITH BEST PRACTICES AND THE CONTRACTOR IS RESPONSIBLE FOR INSTALLING THEM ACCORDING TO THESE CONDITIONS. THE DRAWINGS ONLY SHOW SPECIAL CONDITIONS TO ASSIST THE CONTRACTOR, THEY DO NOT ILLUSTRATE EVERY SUCH CONDITION AND DETAIL.
  USE OF MOISTURE RESISTANT TREATED WOOD BLOCKING IN CONSTRUCTION SHALL USE THE FOLLOWING GUIDELINES: CARBON
- STEEL, ALUMINUM AND ELECTROPLATED GALVANIZED STEEL FASTENERS AND CONNECTORS SHOULD NOT BE USED IN CONTACT WITH TREATED WOOD. HOT DIPPED GALVANIZED FASTENERS COMPLYING WITH ASTM A153 AND CONNECTORS COMPLYING WITH ASTM A653, CLASS G185, GENERALLY ARE ACCEPTABLE. TYPE 304 OR TYPE 316 STAINLESS STEEL FASTENERS AND CONNECTORS ARE RECOMMENDED FOR MAXIMUM CORROSION RESISTANCE. FASTENERS WITH PROPRIETARY ANTI-CORROSION COATING MAY BE ACCEPTABLE FOR USE WITH TREATED WOOD. ALUMINUM FASTENERS, FLASHINGS AND ACCESSORY PRODUCTS SHOULD NOT BE USED IN DIRECT CONTACT WITH ANY TREATED WOOD. ACQ-TREATED WOOD IS NOT COMPATIBLE WITH ALUMINUM. UNCOATED METAL AND PAINTED METAL FLASHING AND ACCESSORIES, EXCEPT FOR 300 SERIES STAINLESS STEEL SHOULD NOT BE USED IN DIRECT CONTACT WITH TREATED WOOD. METAL PRODUCTS, EXCEPT STAINLESS STEEL MAY BE USED IF SEPARATED FROM TREATED WOOD BY A SPACER OR BARRIER SUCH AS SINGLE-PLY MEMBRANE OR SELF-ADHERED POLYMER-MODIFIED BITUMEN MEMBRANE MATERIAL. THE USE OF NON TREATED, CONSTRUCTION GRADE WOOD IS SUITABLE FOR USE AS BLOCKING OR NAILERS, PROVIDED REASONABLE MEASURES ARE TAKEN TO ENSURE THE NON-TREATED WOOD REMAINS REASONABLY DRY WHEN IN SERVICE. IT SHALL BE THE RESPONSIBILITY OF THE CONTRACTOR TO COORDINATE BLOCKING REQUIREMENTS WITH EACH SUB-CONTRACTOR
- NO WORK DEFECTIVE IN CONSTRUCTION OR QUALITY, OR DEFICIENT IN ANY REQUIREMENTS OF DRAWINGS AND SPECIFICATIONS WILL BE ACCEPTABLE IN CONSEQUENCE OF OWNER'S ARCHITECT'S FAILURE TO DISCOVER OR TO POINT OUT DEFECTS OR DEFICIENCIES DURING CONSTRUCTION, NOR WILL PRESENCE OF INSPECTORS ON WORK SITE RELIEVE CONTRACTOR FOR SECURING QUALITY AND PROGRESS OR WORK AS REQUIRED BY CONTRACT. DEFECTIVE WORK REVEALED WITHIN TIME REQUIRED BY GUARANTEES SHALL BE WHETHER PARTIAL OR FINAL SHALL BE CONSTRUED AS AN ACCEPTANCE OF DEFECTIVE WORK OR IMPROPER MATERIALS.


AND IT SHALL BE UP TO THE SUB-CONTRACTOR TO SELECT SUITABLE

METHODS FOR INSTALLING BLOCKING MEETING THE STANDARDS

REFERENCED ABOVE.


- CONTRACTORS, SUB-CONTRACTORS OR SUPPLIERS SHALL NOT PROCEED WITH ANY WORK FOR WHICH HE EXPECTS ADDITIONAL COMPENSATION BEYOND THE WRITTEN AUTHORIZATION FROM CONTRACTOR OR OWNER. FAILURE TO OBTAIN SUCH AUTHORIZATION MAY INVALIDATE ANY CLAIM FOR ADDITIONAL COMPENSATION.

  THE CONTRACTOR IS TO COORDINATE AND SCHEDULE PUNCH LIST TO
- TAKE PLACE A MINIMUM OF 5 WORKING DAYS BEFORE SCHEDULED OCCUPANCY DATE. PROVIDE NOTIFICATION TO ARCHITECT AND OWNER WHEN PUNCH LIST ITEMS HAVE BEEN COMPLETED OR WHICH ITEMS REMAIN AND WHY. COORDINATE REQUIRED WORK WITH OWNER AND PROTECT AND/OR MOVE ANY OWNER ITEMS AND FURNITURE IF NEEDED. PUNCH LIST ITEMS MUST BE COMPLETED WITHIN 30 CALENDAR DAYS OF PUNCH LIST DATE.
- A "CERTIFICATE OF OCCUPANCY" SHALL BE OBTAINED PRIOR TO MOVE IN DATE AND PRESENTED TO OWNER AT TIME OF PUNCH LIST WALK
  THROUGH.

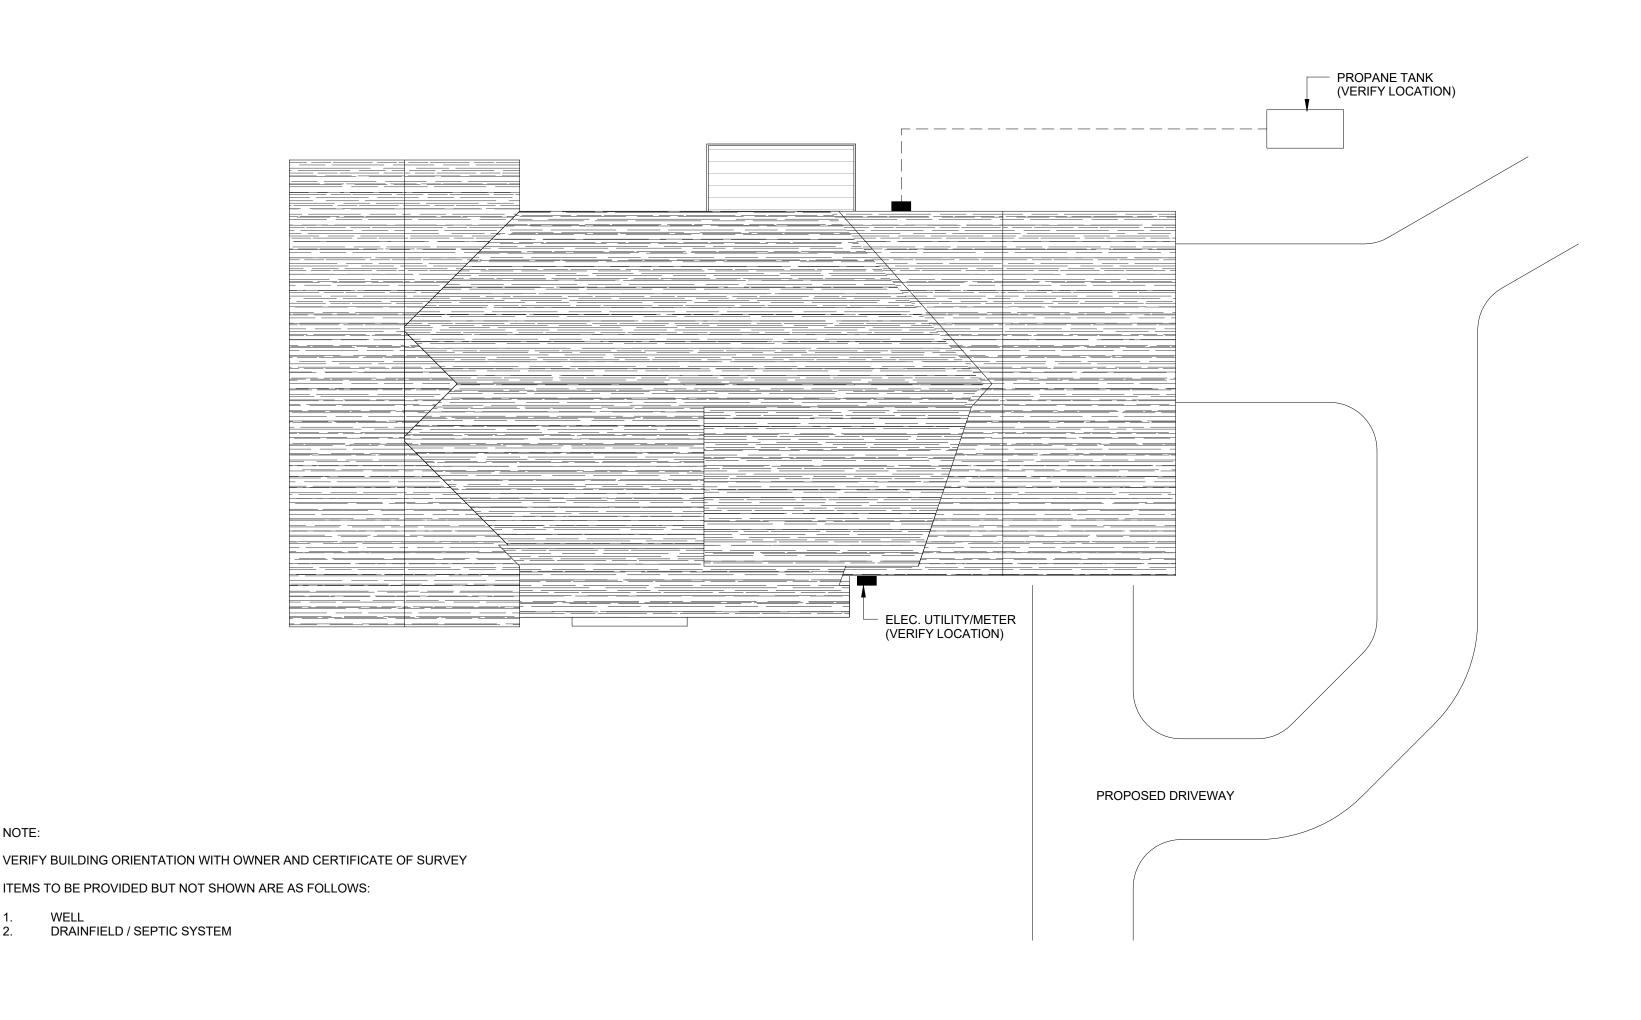


1 SITE PLA 1" = 10'-0 SKSON RESIDENCE
O OLDFIELD AVE N N
LE SHEET / SITE

AWN BY: BKS
SIGNED BY: WER
OJECT NUMBER: RA18011

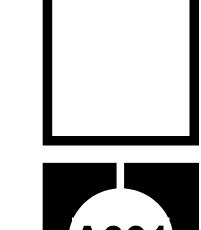

COPYRIGHT© 2015 RUST ARCHITECTS, PA

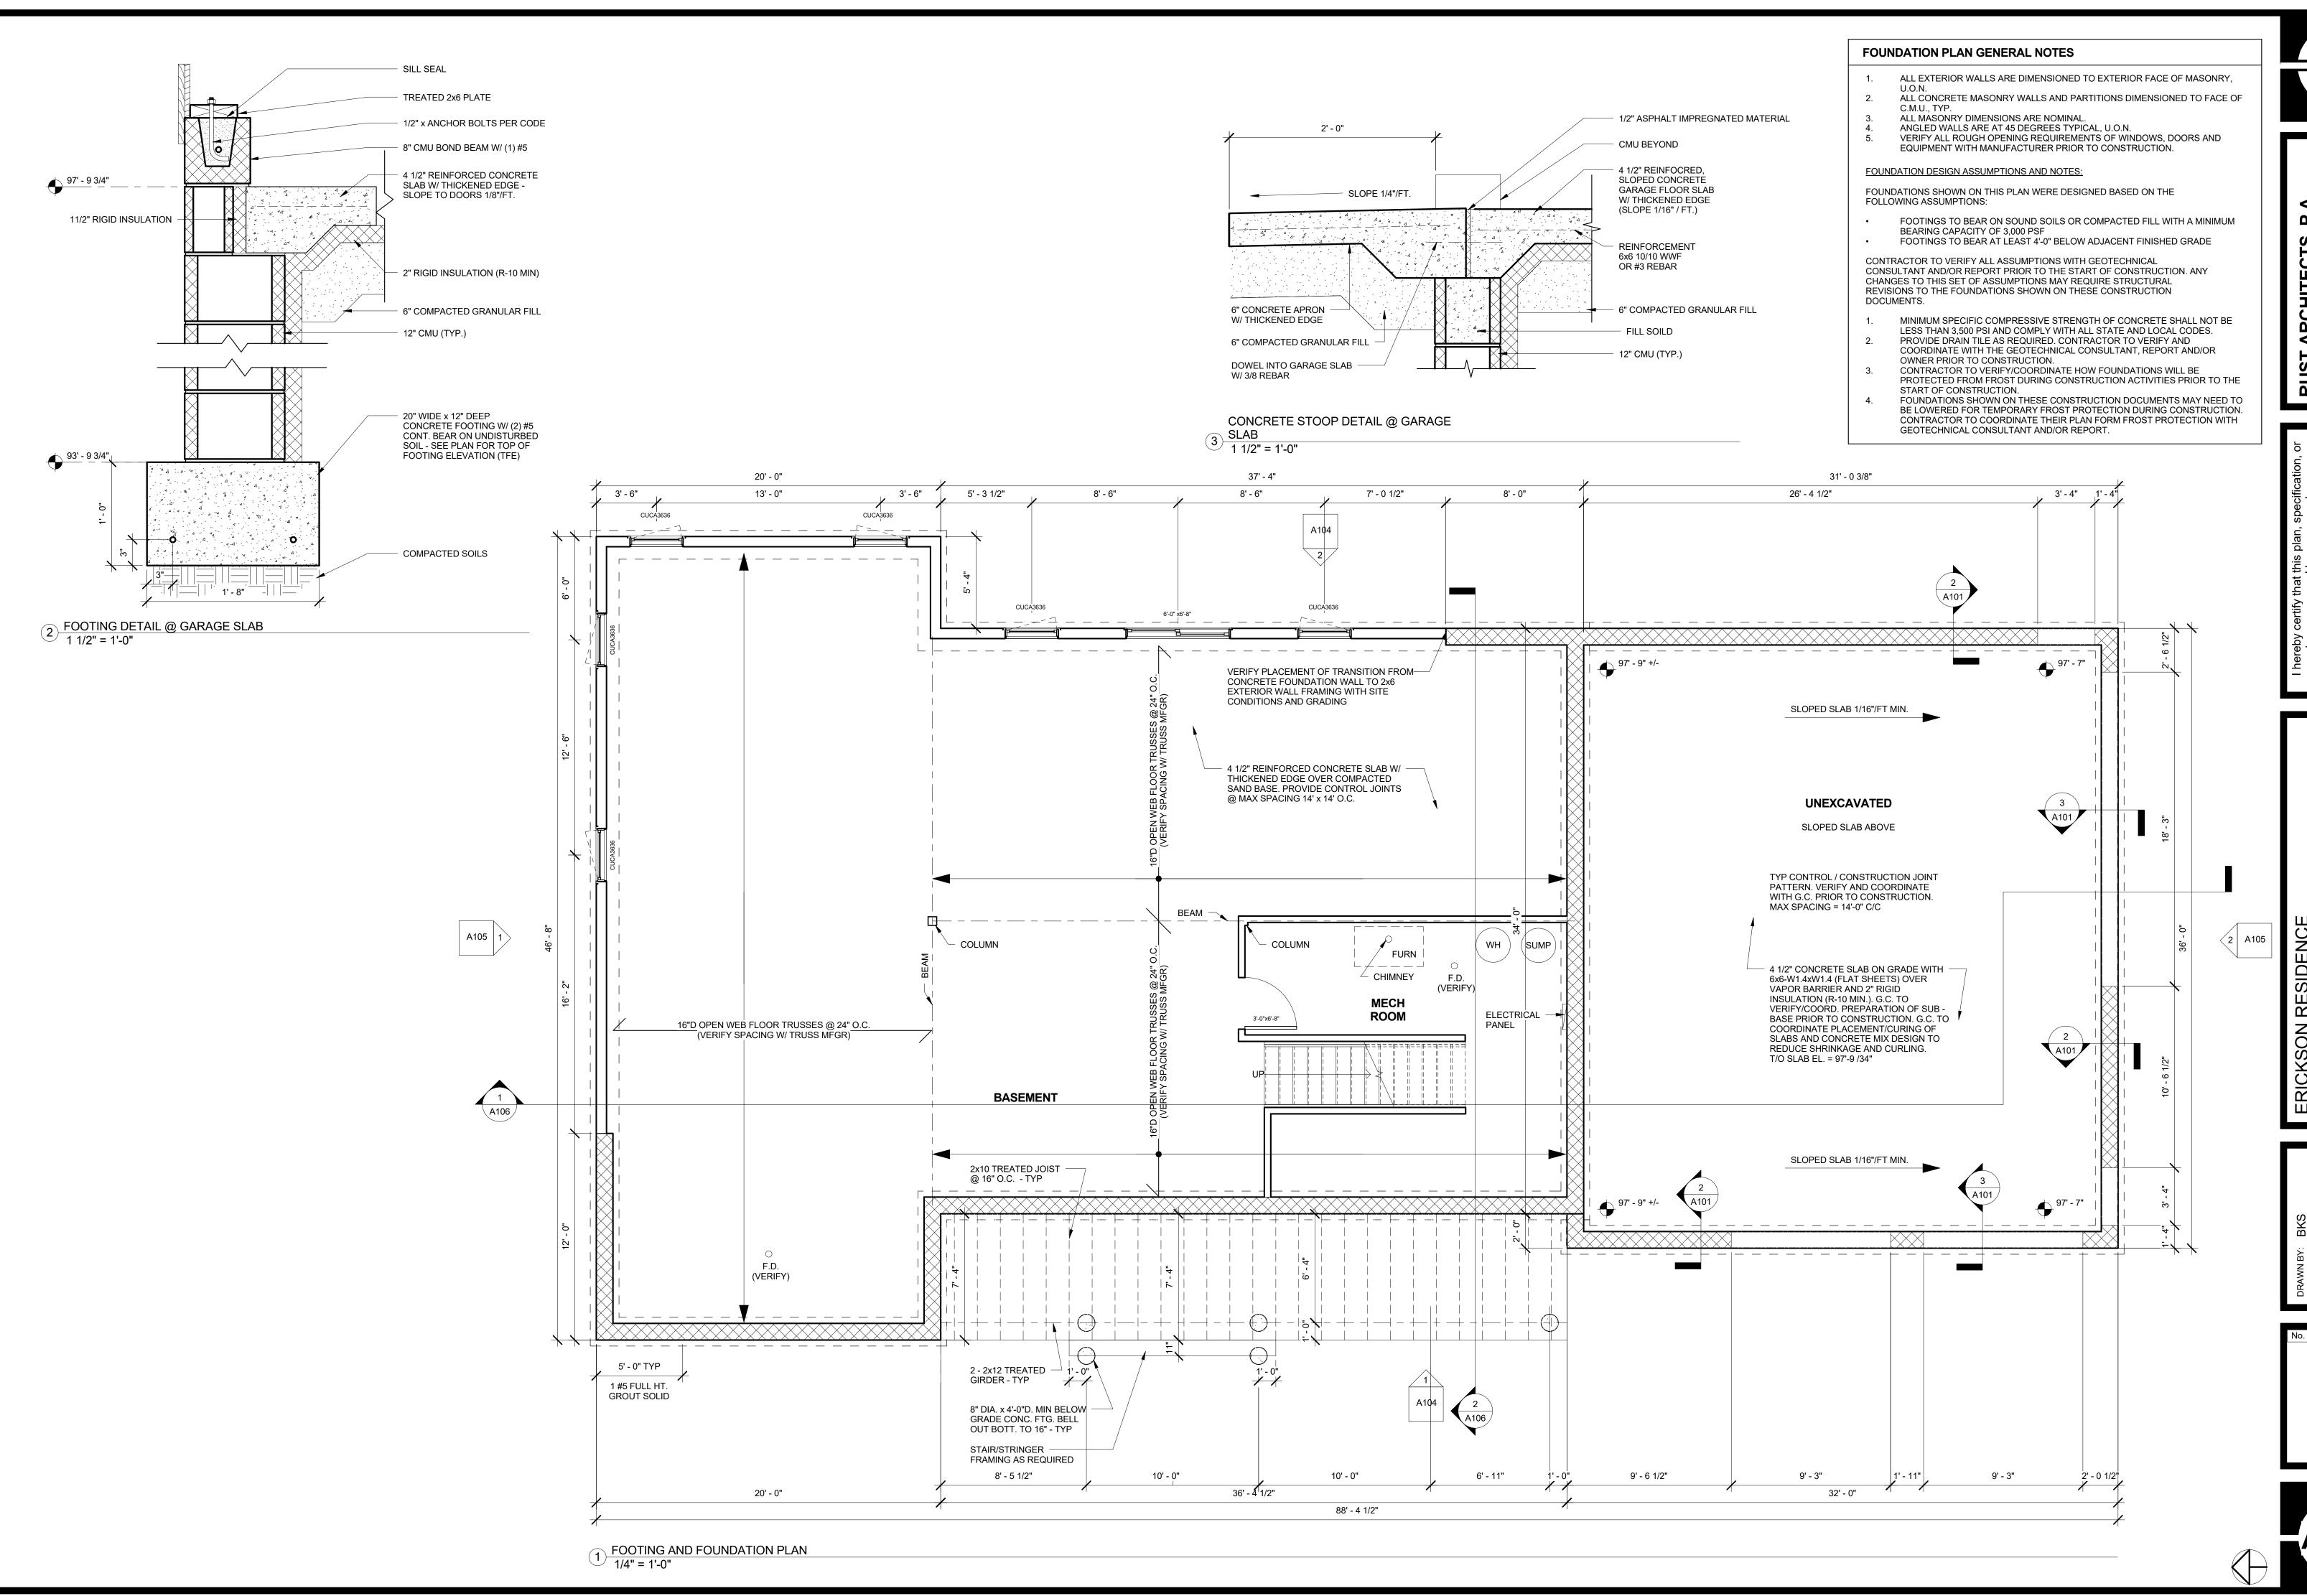




Z Z AND DE

ERICKSON RESIDENCE 23359 OLDFIELD AVE N FOUNDATION



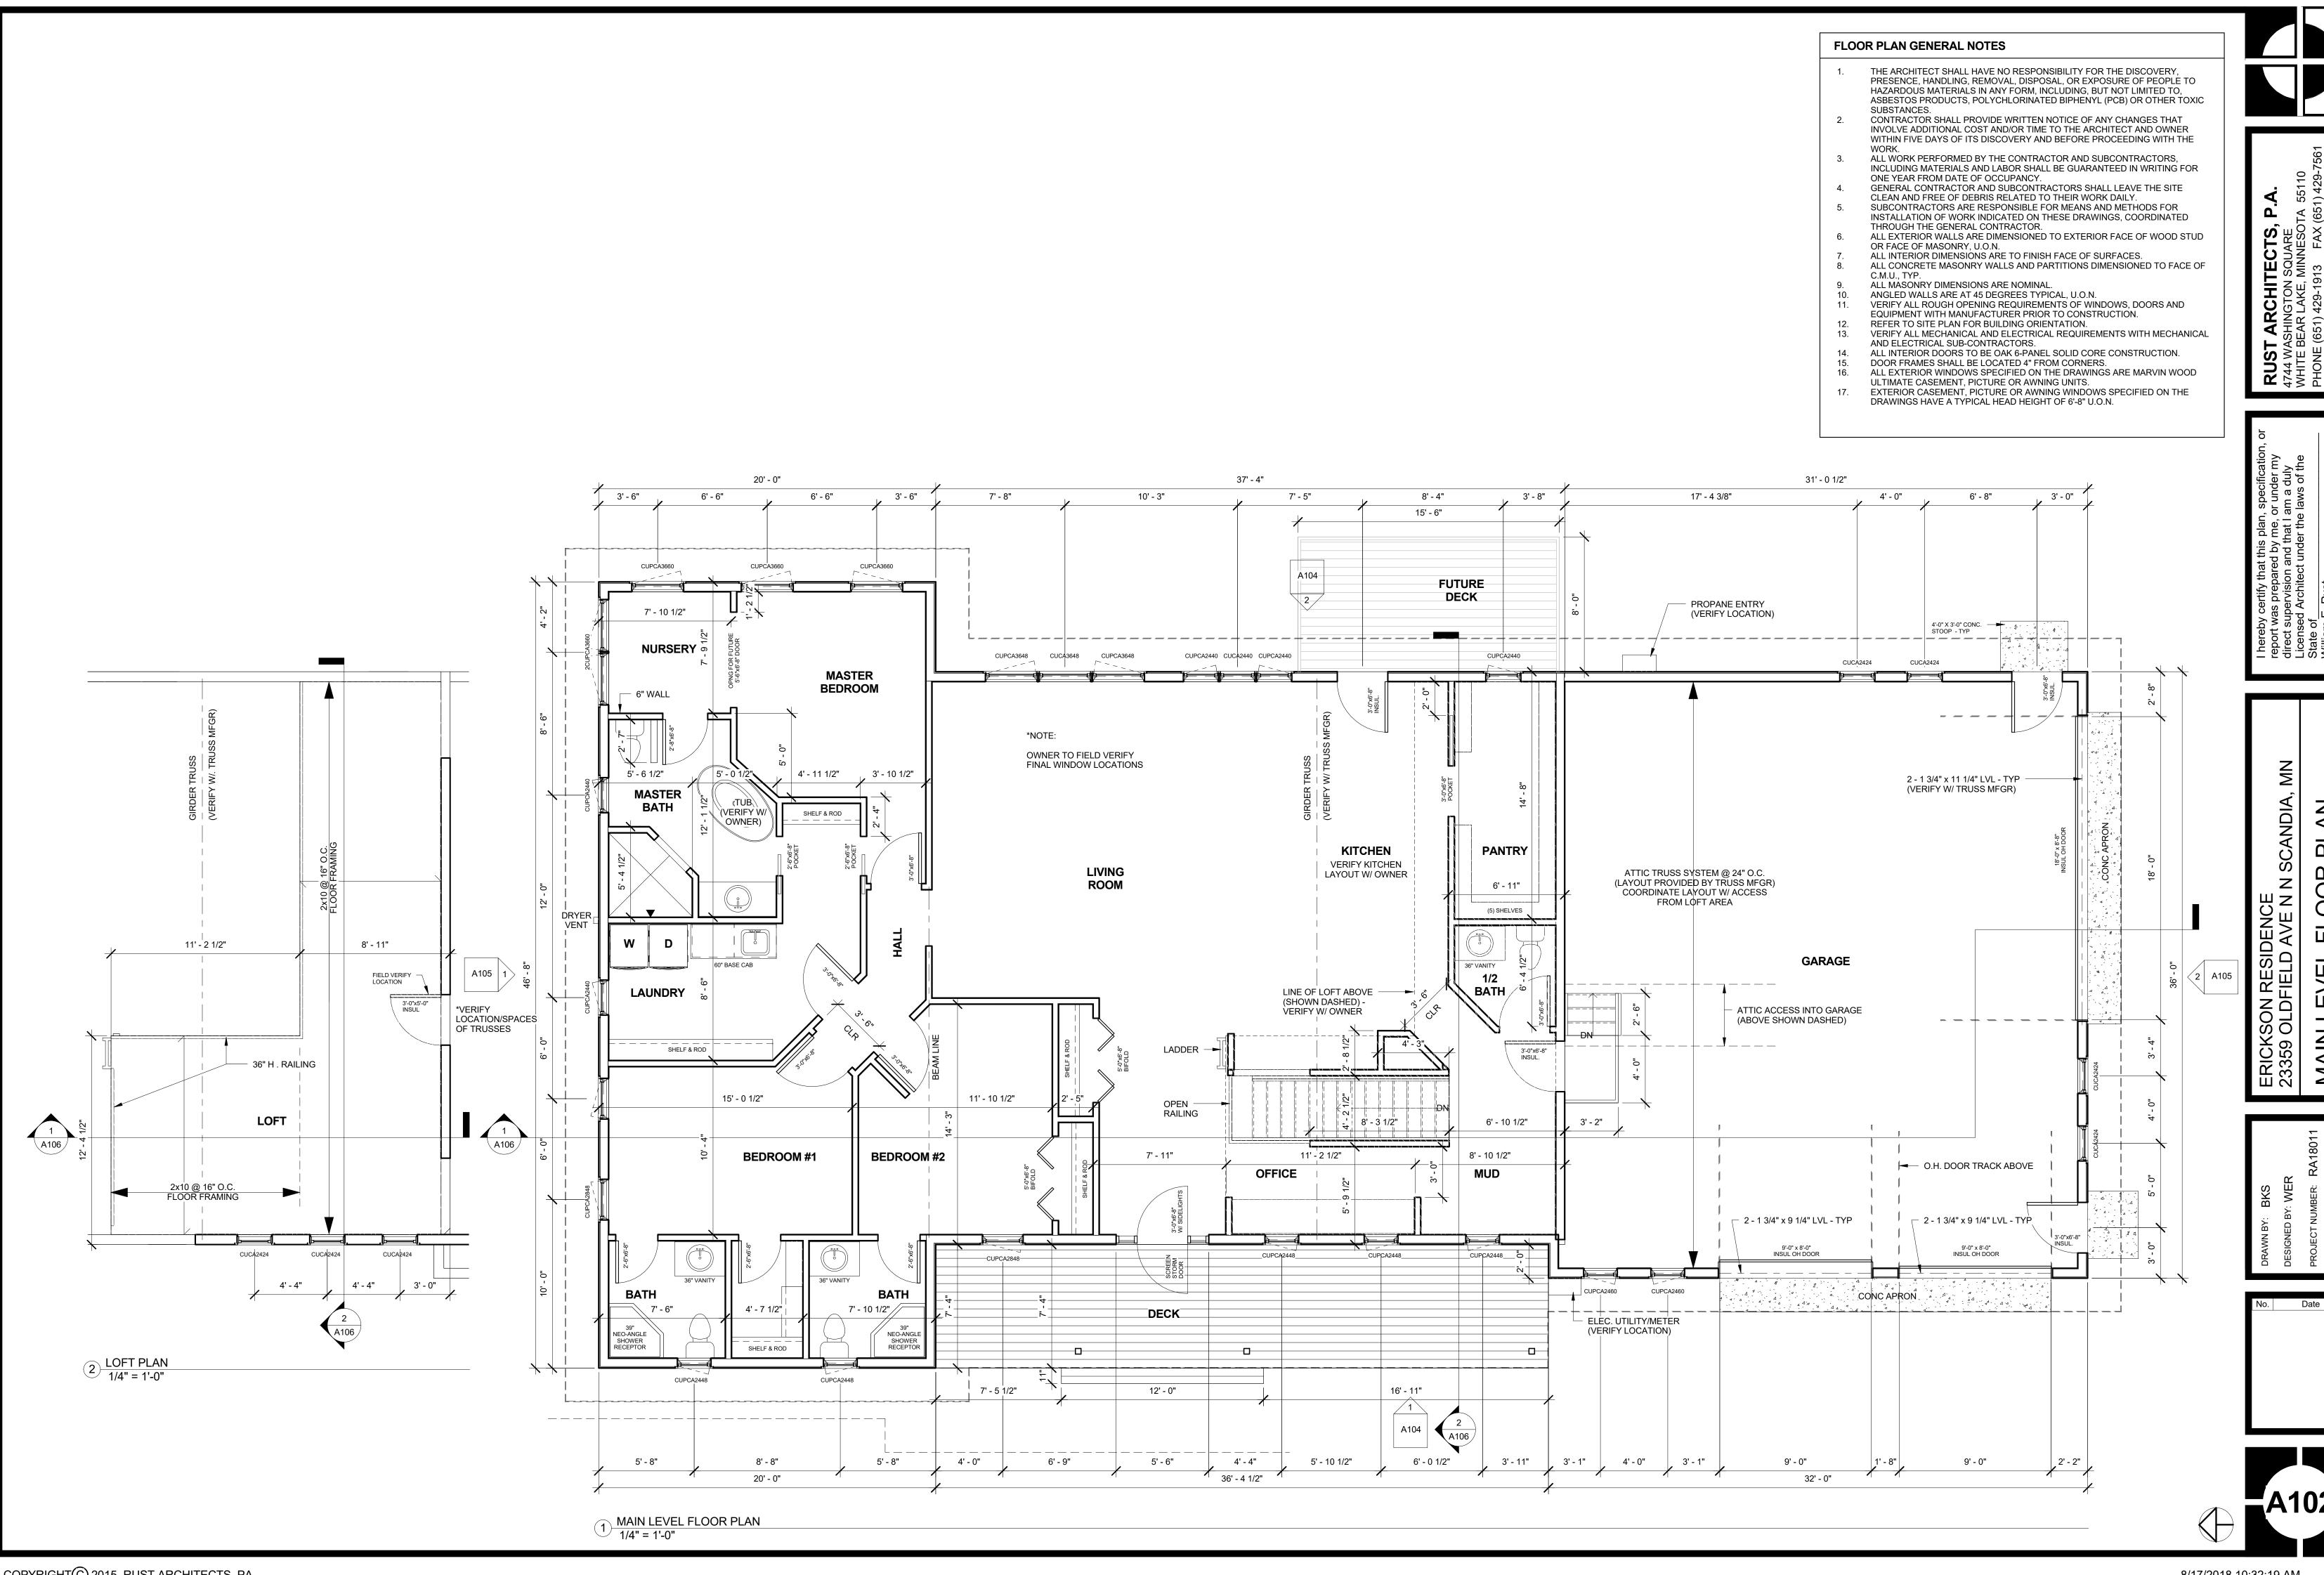

#### ROOF PLAN GENERAL NOTES

- 1. VENTILATION AREA IS TO BE PROVIDED AT THE ATTIC SPACE WITH 1:300 RATIO FOR VAPOR RETARDER EXCEPTION. 50% OF THE REQUIRED VENTILATING AREA TO BE PROVIDED BY VENTILATORS LOCATED IN THE UPPER PORTION OF THE SPACE TO BE VENTILATED AT LEAST 3 FEET ABOVE THE EAVE OR CORNICE VENTS (AT ROOF RIDGE). THE BALANCE (50%) OF THE REQUIRED VENTILATION TO BE PROVIDED BY EAVE OR CORNICE VENTS (MSBC 2015 1203 2)
- CORNICE VENTS (MSBC 2015 1203.2).

  2. EXTERIOR OPENINGS INTO THE ATTIC SPACE SHALL BE COVERED WITH CORROSION RESISTANT WIRE CLOTH SCREENING, HARDWARE CLOTH, PERFORATED VINYL OR SIMILAR MATERIAL TO PREVENT THE ENTRY OF SMALL CREATURES. OPENINGS SHALL THEREFORE BE 1/16" MINIMUM AND 1/4" MAXIMUM IN SIZE (MSBC 2015 1203.2.1).
- AN OPENING NOT LESS THAN 20" x30" SHALL BE PROVIDED TO ATTIC. A 30" MINIMUM CLEAR HEADROOM IN THE ATTIC SPACE SHALL BE PROVIDED AT OR ABOVE THE ACCESS OPENINGS (MSBC 2015 1209.2).
   SELF-ADHERED ICE AND WATER SHIELD TO RUN FROM EAVES
- TO 2'-0" INSIDE THE EXTERIOR WALL LINE.
  ROOF VALLEY FLASHING SHALL BE CORROSION RESISTANT
  METAL (PREFINISHED ALUMINUM) AND SHALL EXTEND AT
  LEAST 12" FROM THE CENTER LINE OF THE VALLEY EACH
- WAY.
  ALL RIDGE VENTS TO BE RATED A NET FREE AREA OF 18
  SQUARE INCHES (S.I.) PER LINEAL FOOT MINIMUM, TYPICAL.
  ALL EAVE/SOFFIT VENTING TO BE ROLLEX SYSTEM 3

SQUARE INCHES (S.I.) PER LINEAL FOOT MINIMUM.

ALUMINUM SOFFIT SYSTEM, CENTER VENTED, RATED AT 6.48

8. PROVIDE SPECIFICATIONS, SAMPLES, AND COLOR SELECTIONS TO ARCHITECT FOR APPROVAL FOR RIDGE VENTS AND ROOF VENTS. FINISH FOR ALL ROOF PENETRATIONS & VENTS TO MATCH ROOF.

my 4744 WASHING WHITE BEAR L. PHONE (651) 4

t supervision and that I am a du ised Architect under the laws of of Incense No.


direct supervisior
Licensed Archite
State of
William E. Rust
Date


ENCE IVE N N SCANDIA, MN

ERICKSON RESIDENCE 23359 OLDFIELD AVE N

SIGNED BY: WER


No. Date

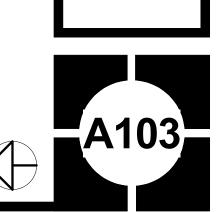

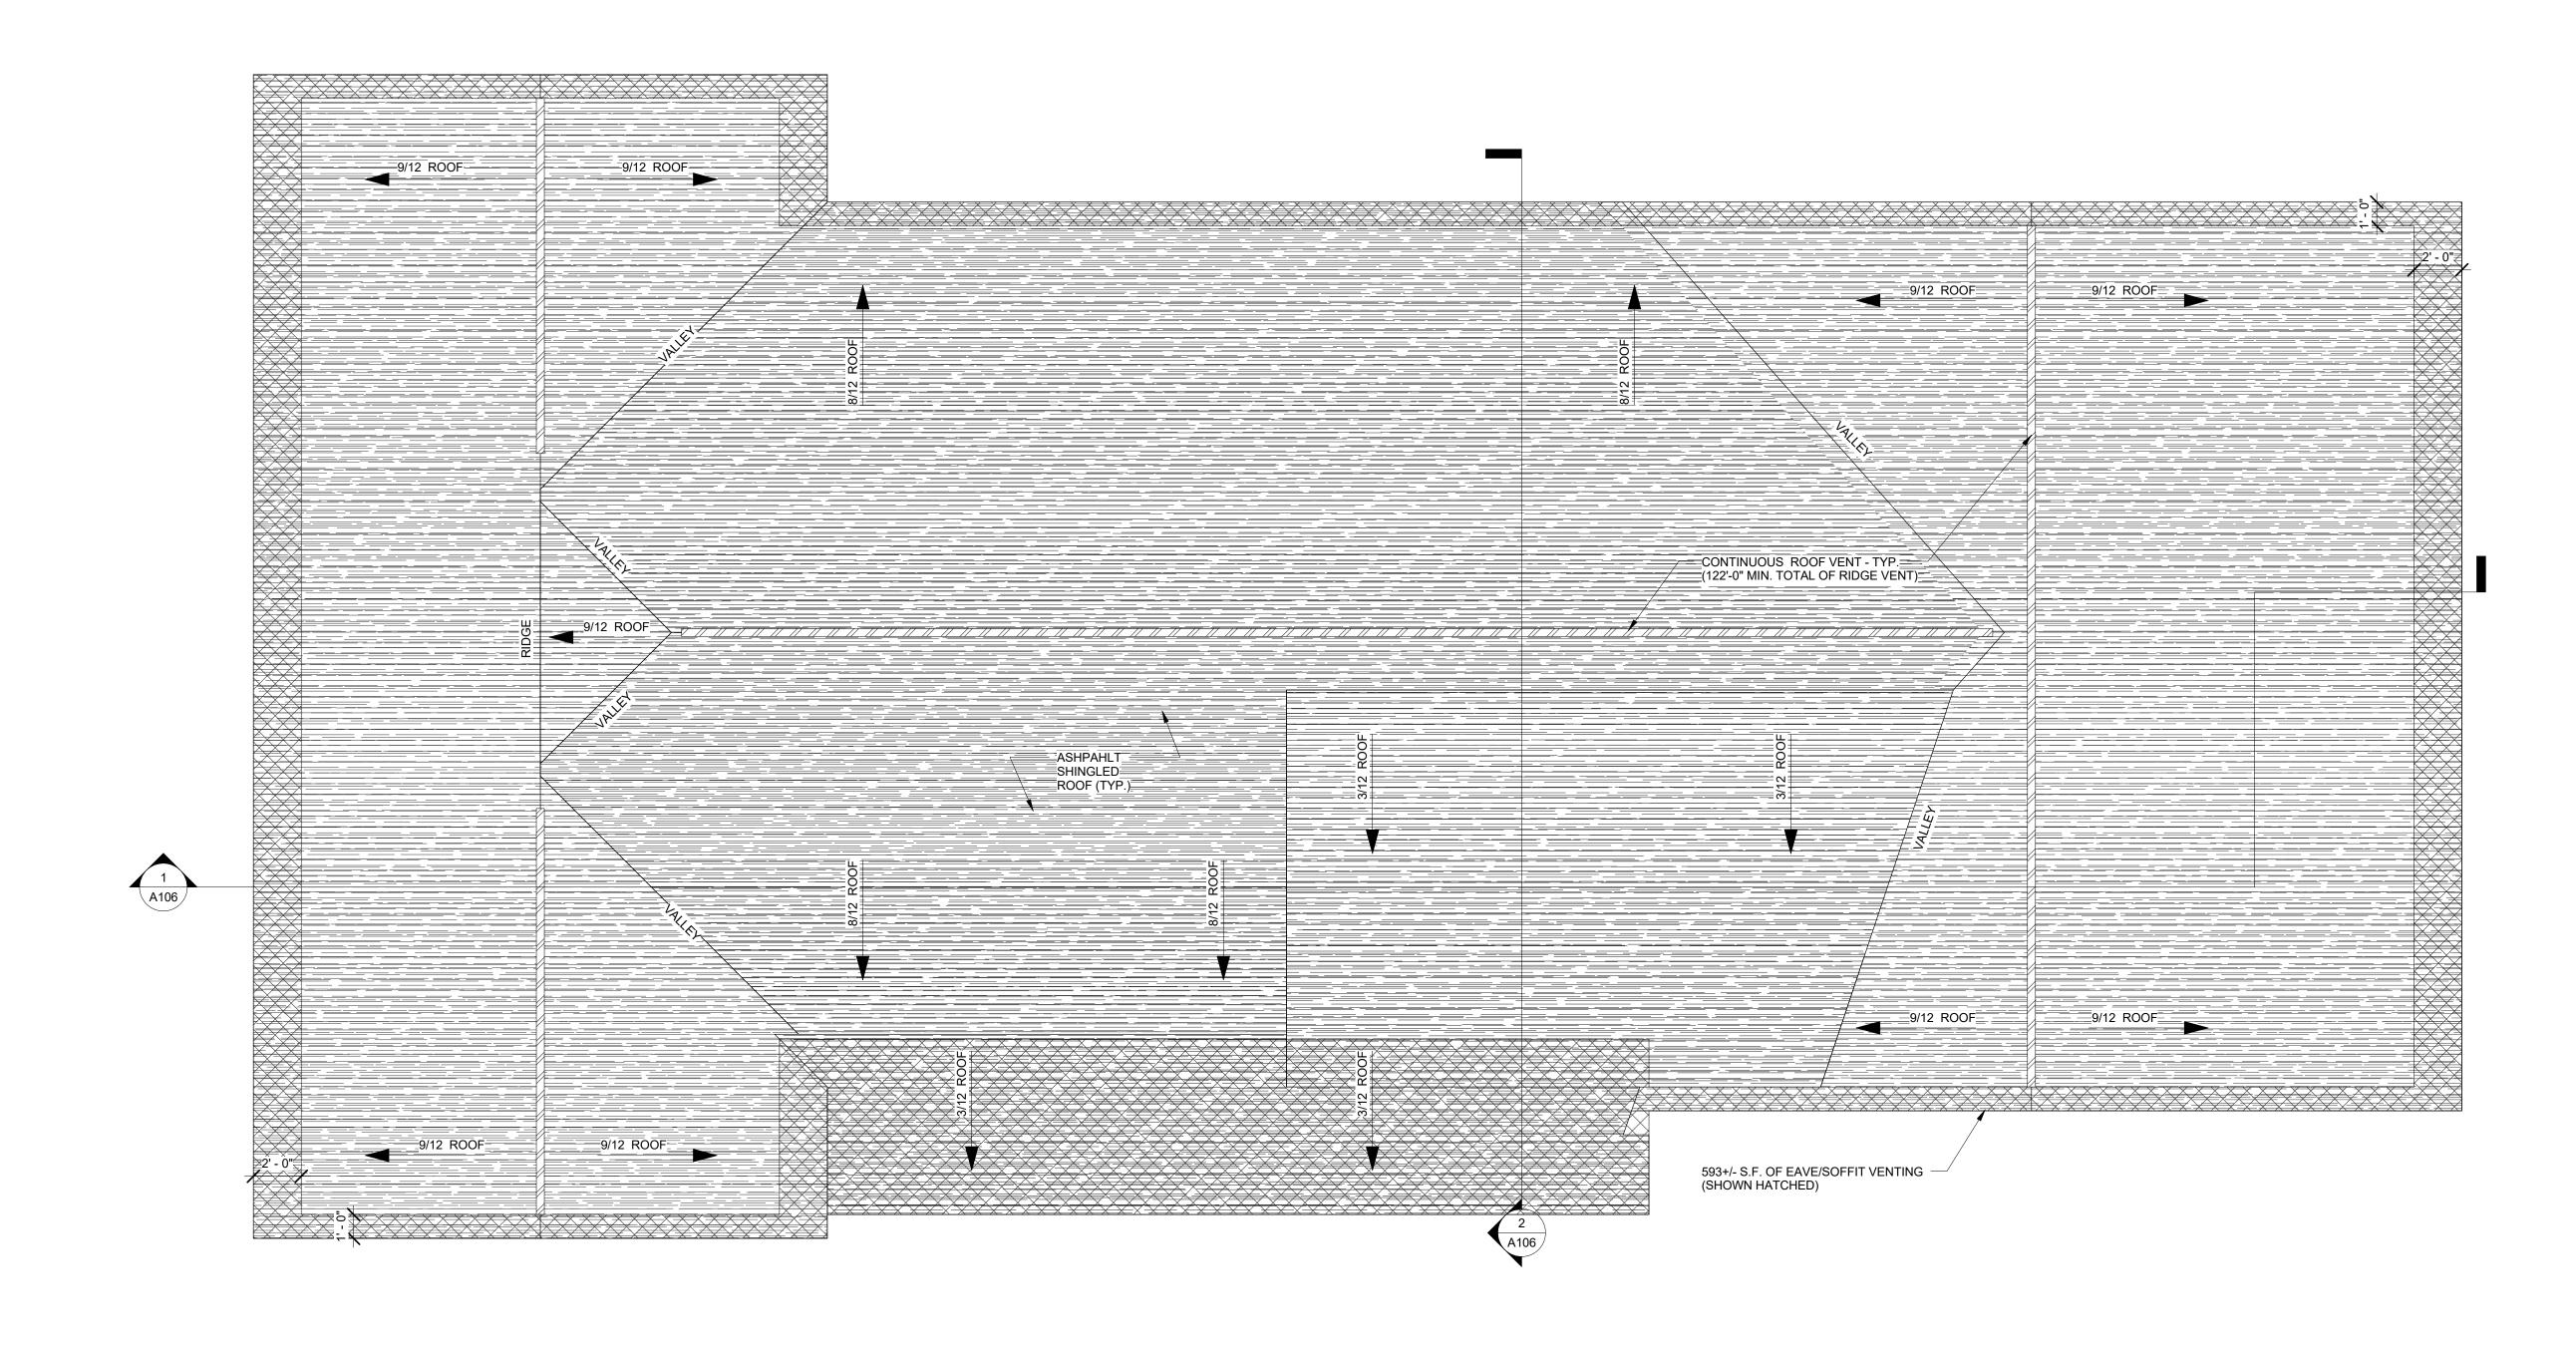



1) ROOF PLAN 1/4" = 1'-0"

ERICKSON RESIDENCE 23359 OLDFIELD AVE N

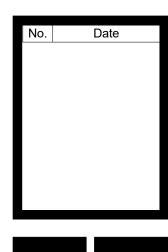


ERICKSON RESIDENCE 23359 OLDFIELD AVE N N

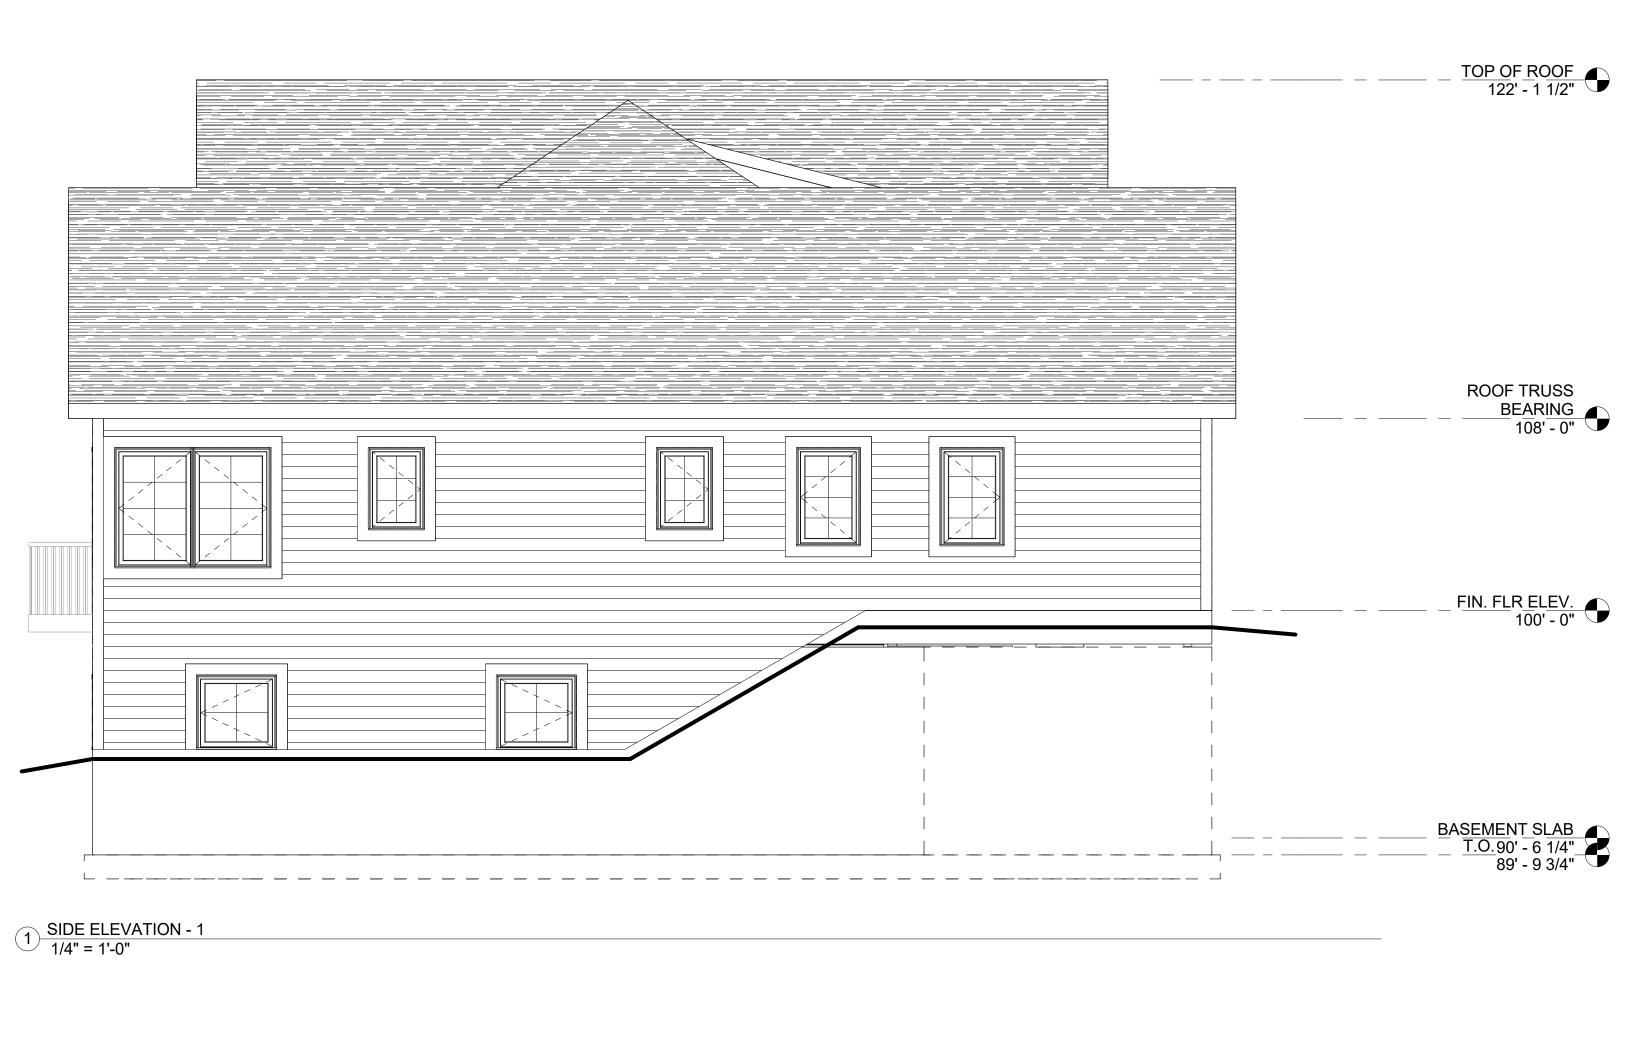


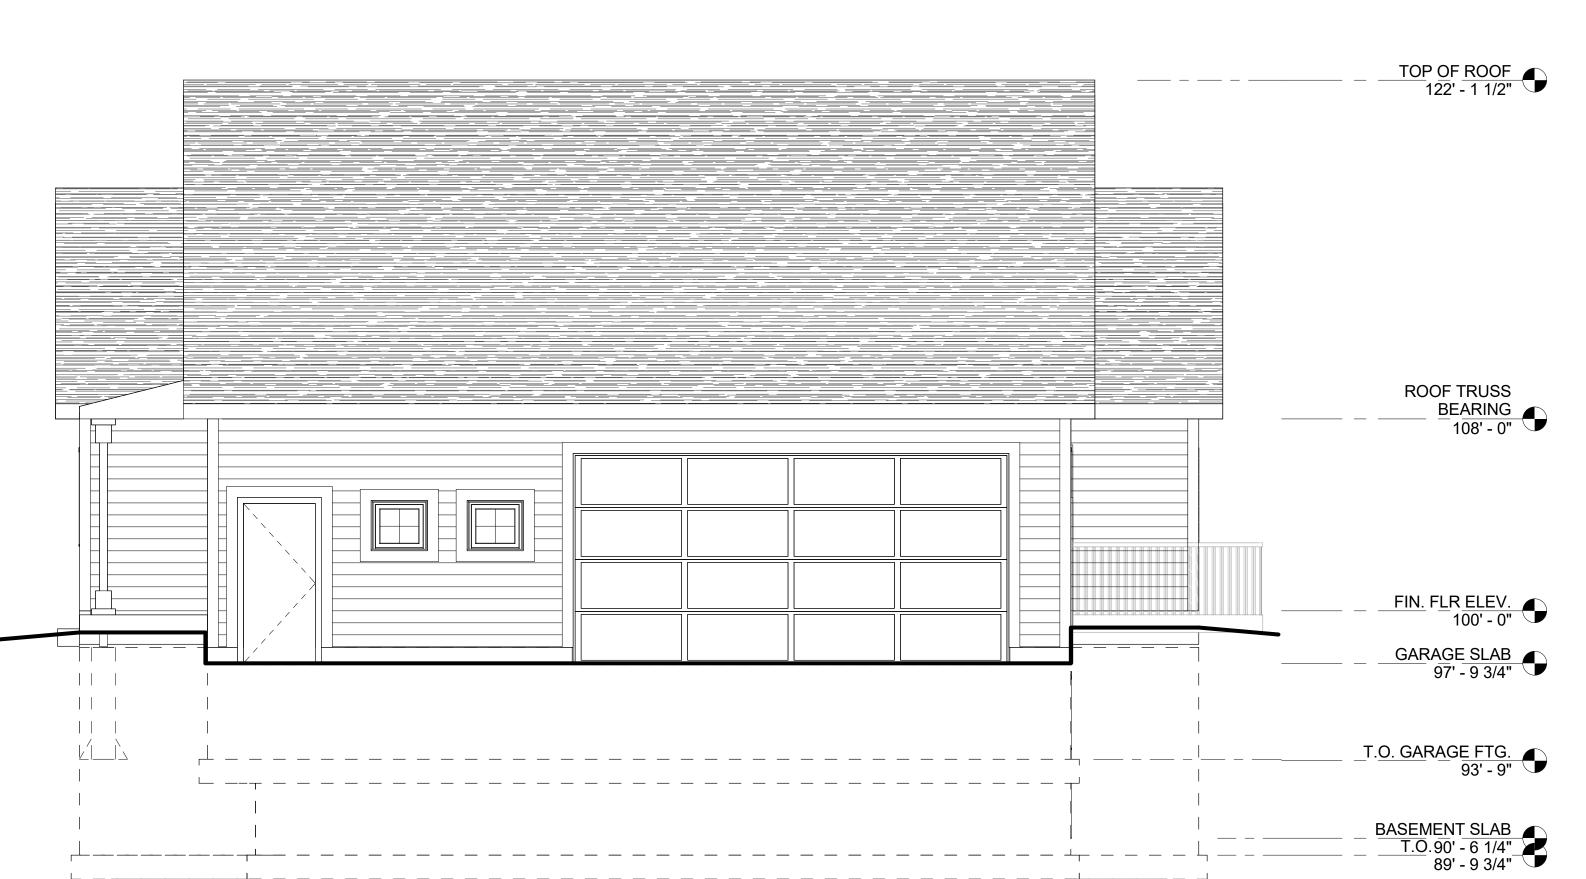


2 SIDE ELEVATION - 2 1/4" = 1'-0"

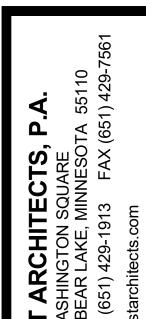


ERICKSON RESIDENCE 23359 OLDFIELD AVE N N BUILDING

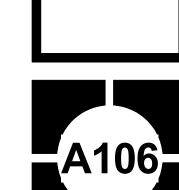

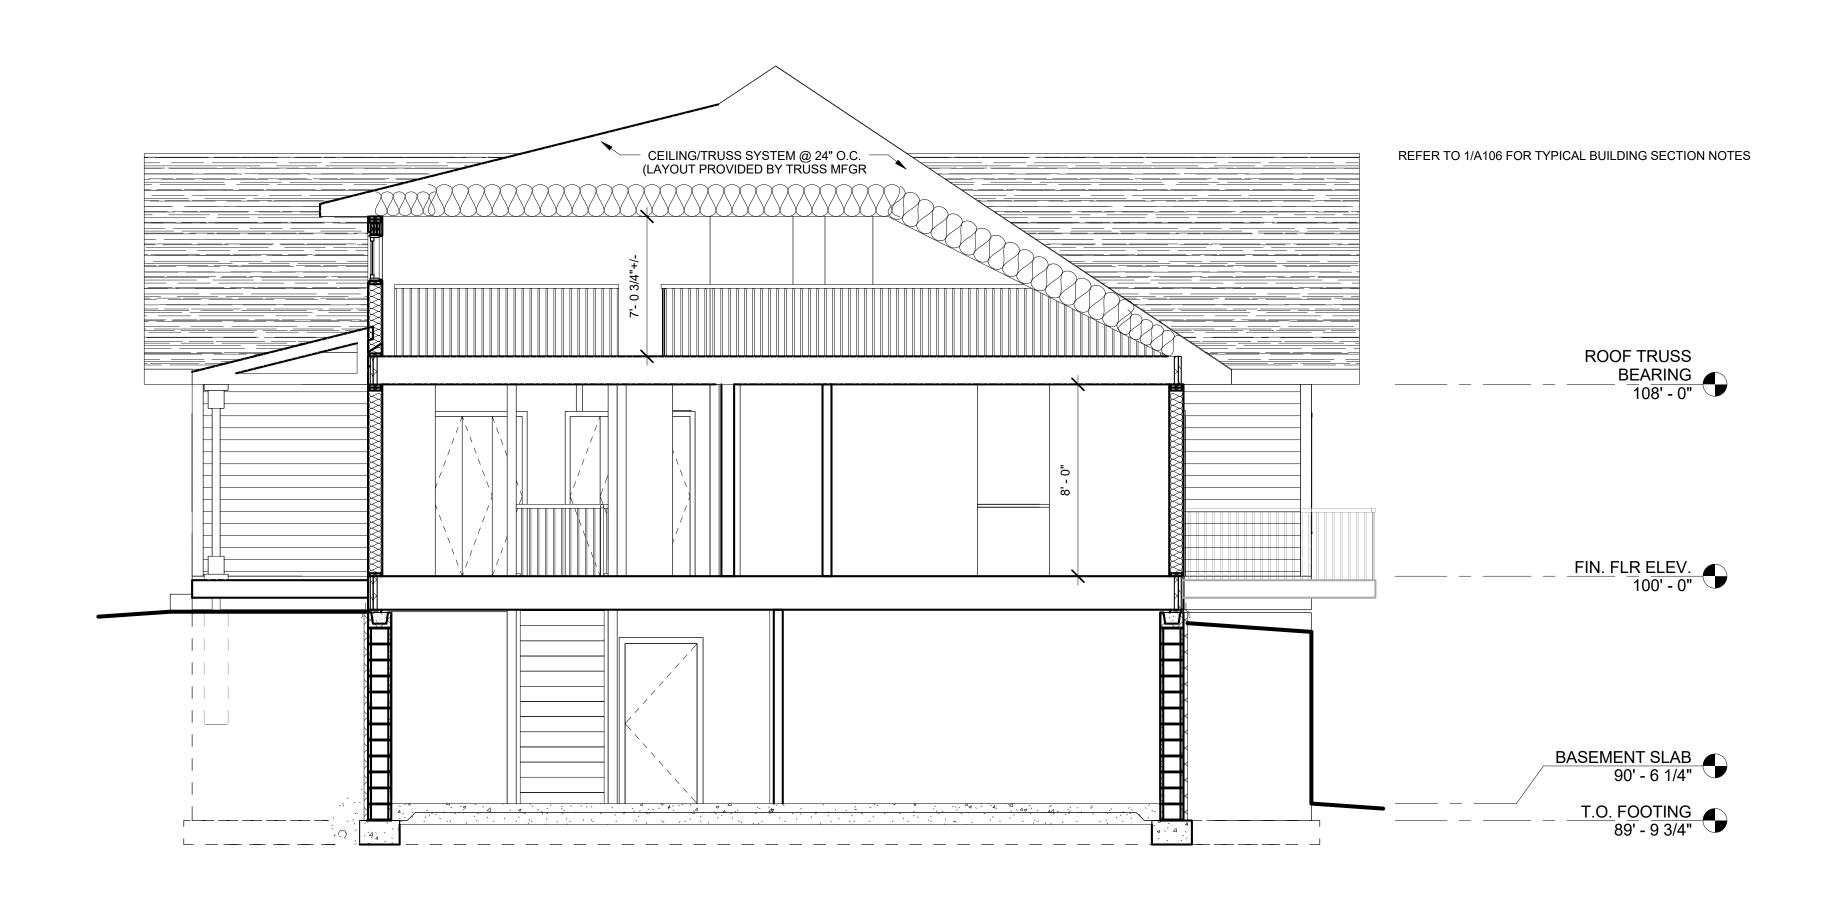

2 BUILDNG SECTION #2 1/4" = 1'-0"

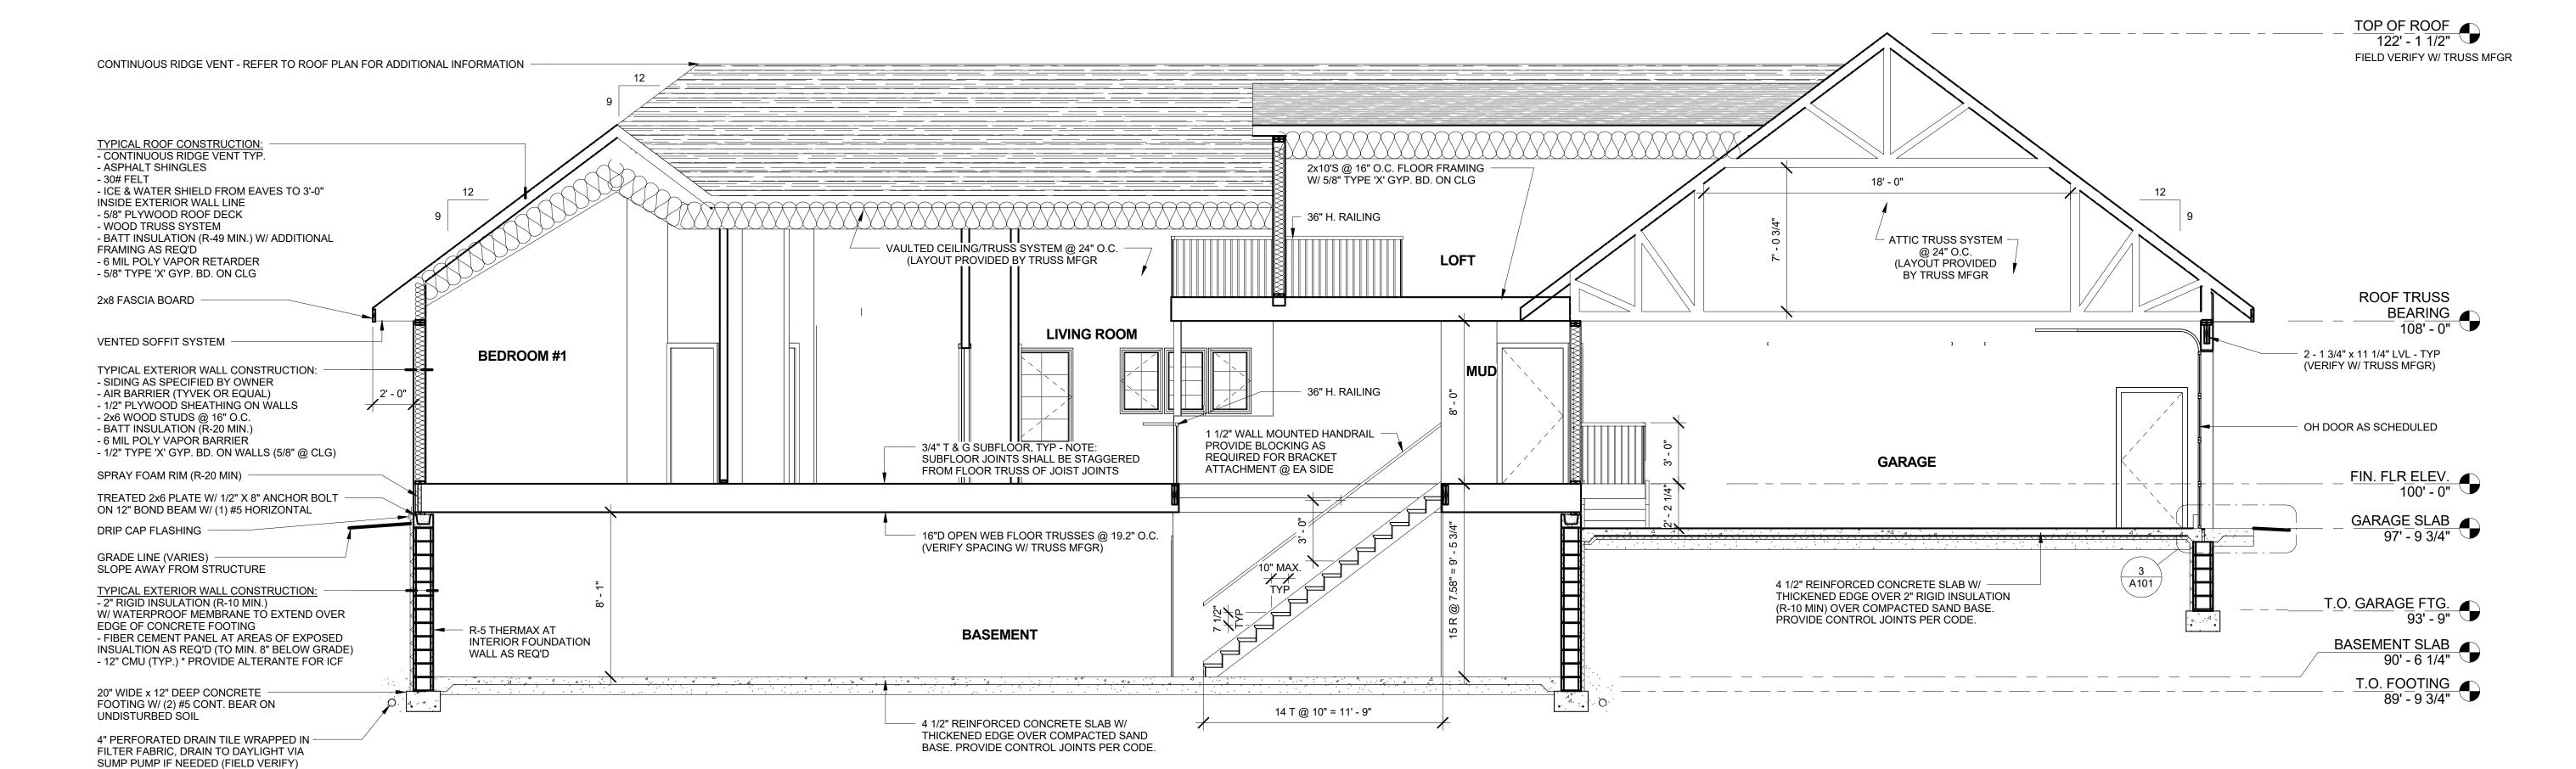

COPYRIGHT© 2015 RUST ARCHITECTS, PA

1 BUILDING SECTION #1 1/4" = 1'-0"