



IMRE & DEBBIE SZAUTER  
2ND FLOOR PLANS  
RT 115 CARROLL, NH  
FEBRUARY 25, 2014  
GARLAND MILL

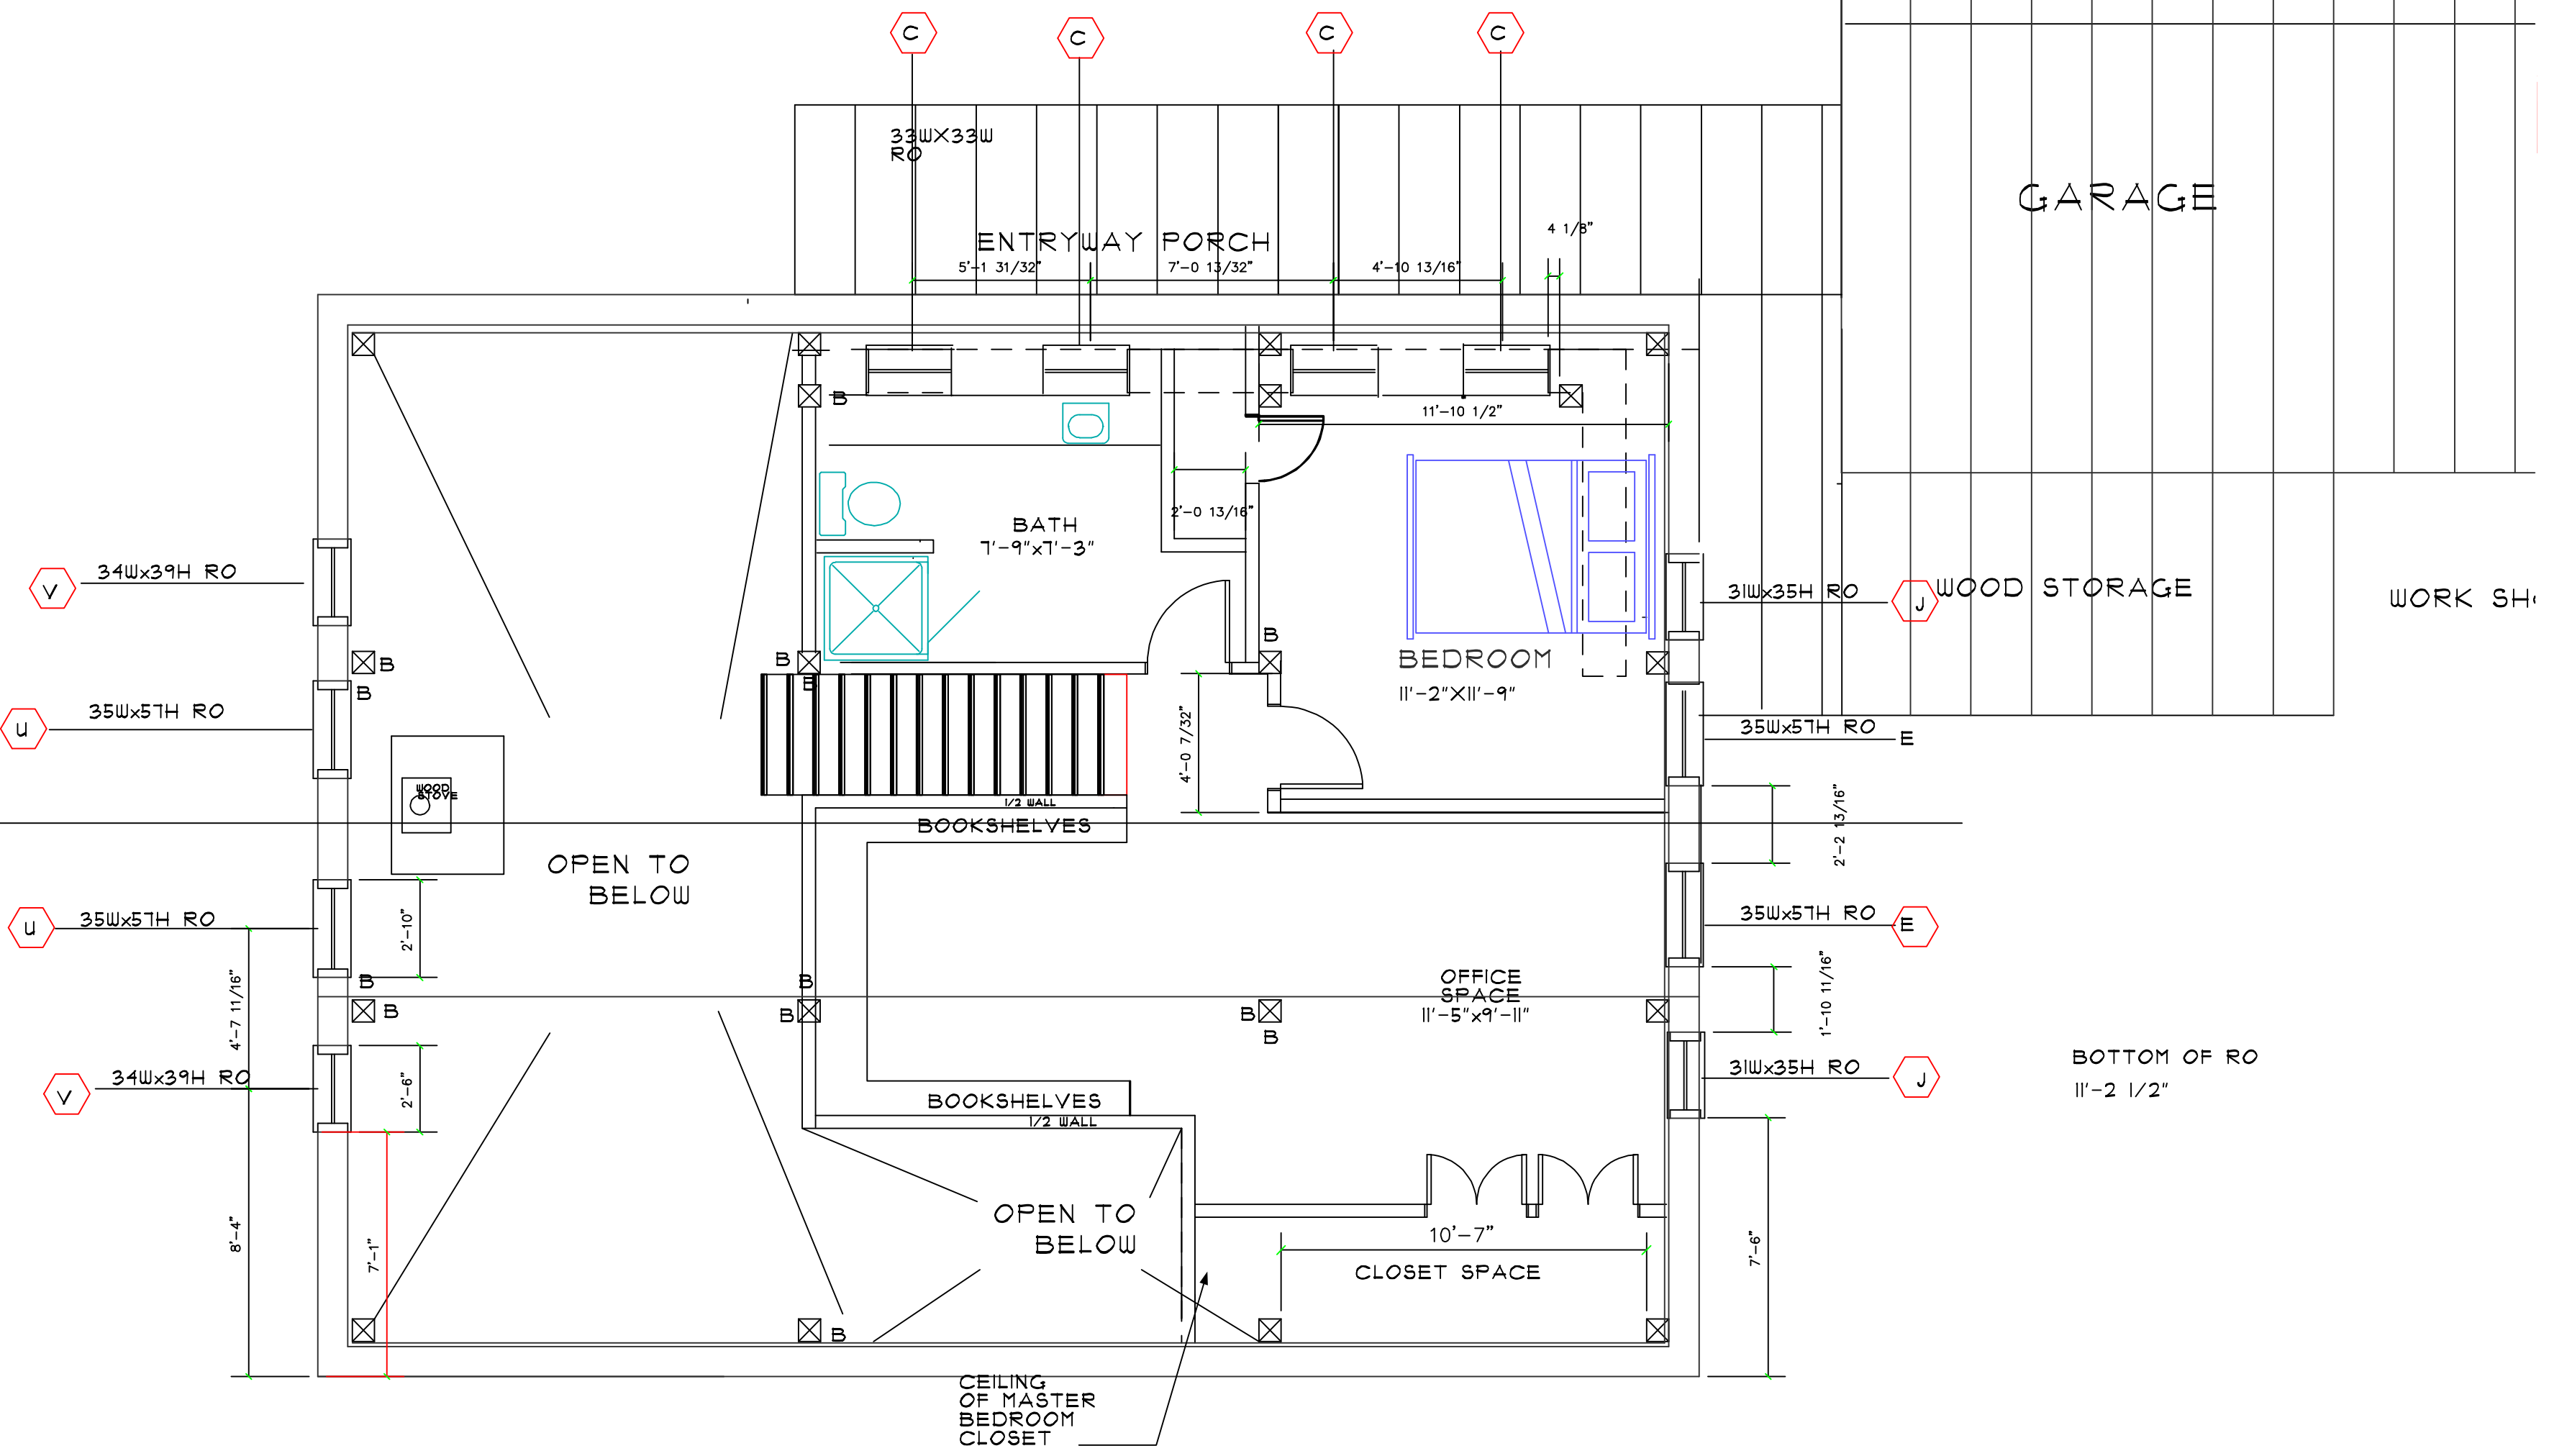

TOP OF RO 16'-3"




DETAILS ARE TYPICAL OF STANDARD  
CONDITIONS AND MAY NOT APPLY  
IN ALL SITUATIONS. PLEASE  
CONTACT FPI TECHNICAL  
DEPARTMENT FOR QUESTIONS  
AND/OR CONCERNS.

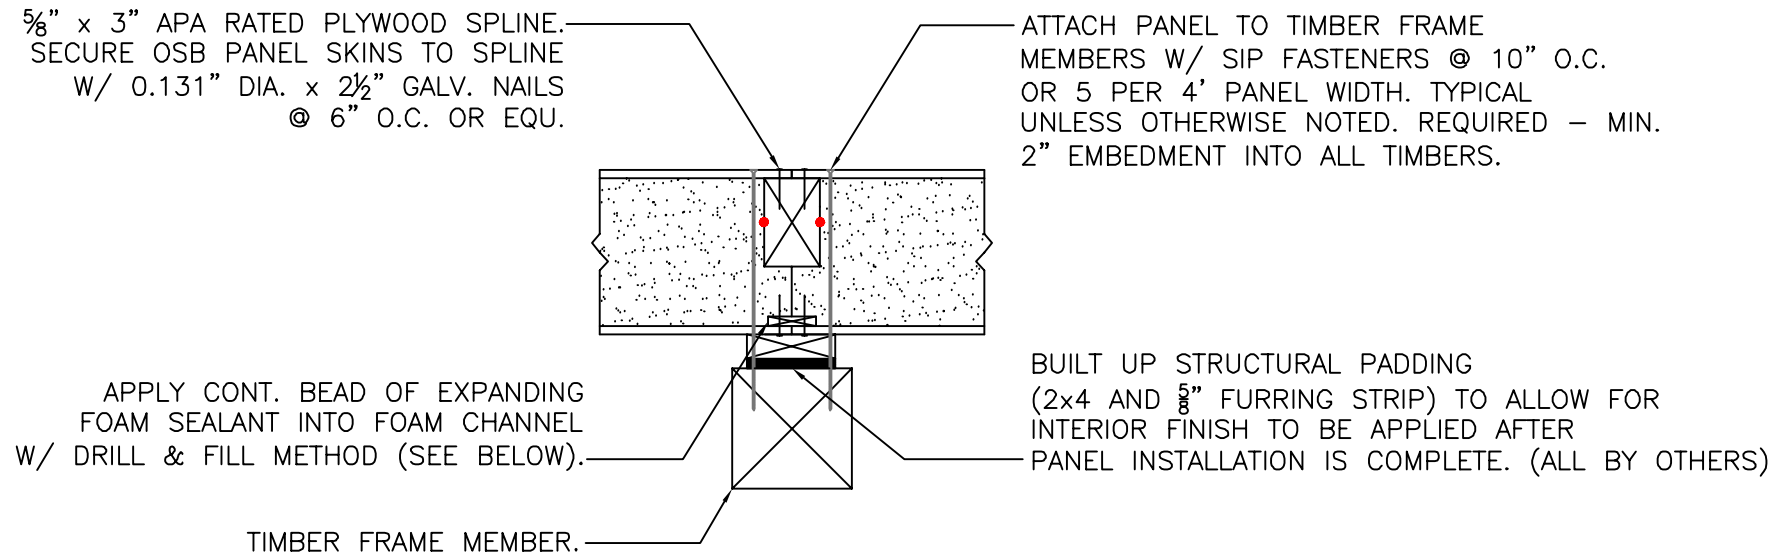

PANEL TYPE: STRUCTURAL PANELS APPLIED DIRECTLY TO PADDED FRAME

EMBEDDED POST DETAIL  
SCALE: 1" = 1'-0"

4

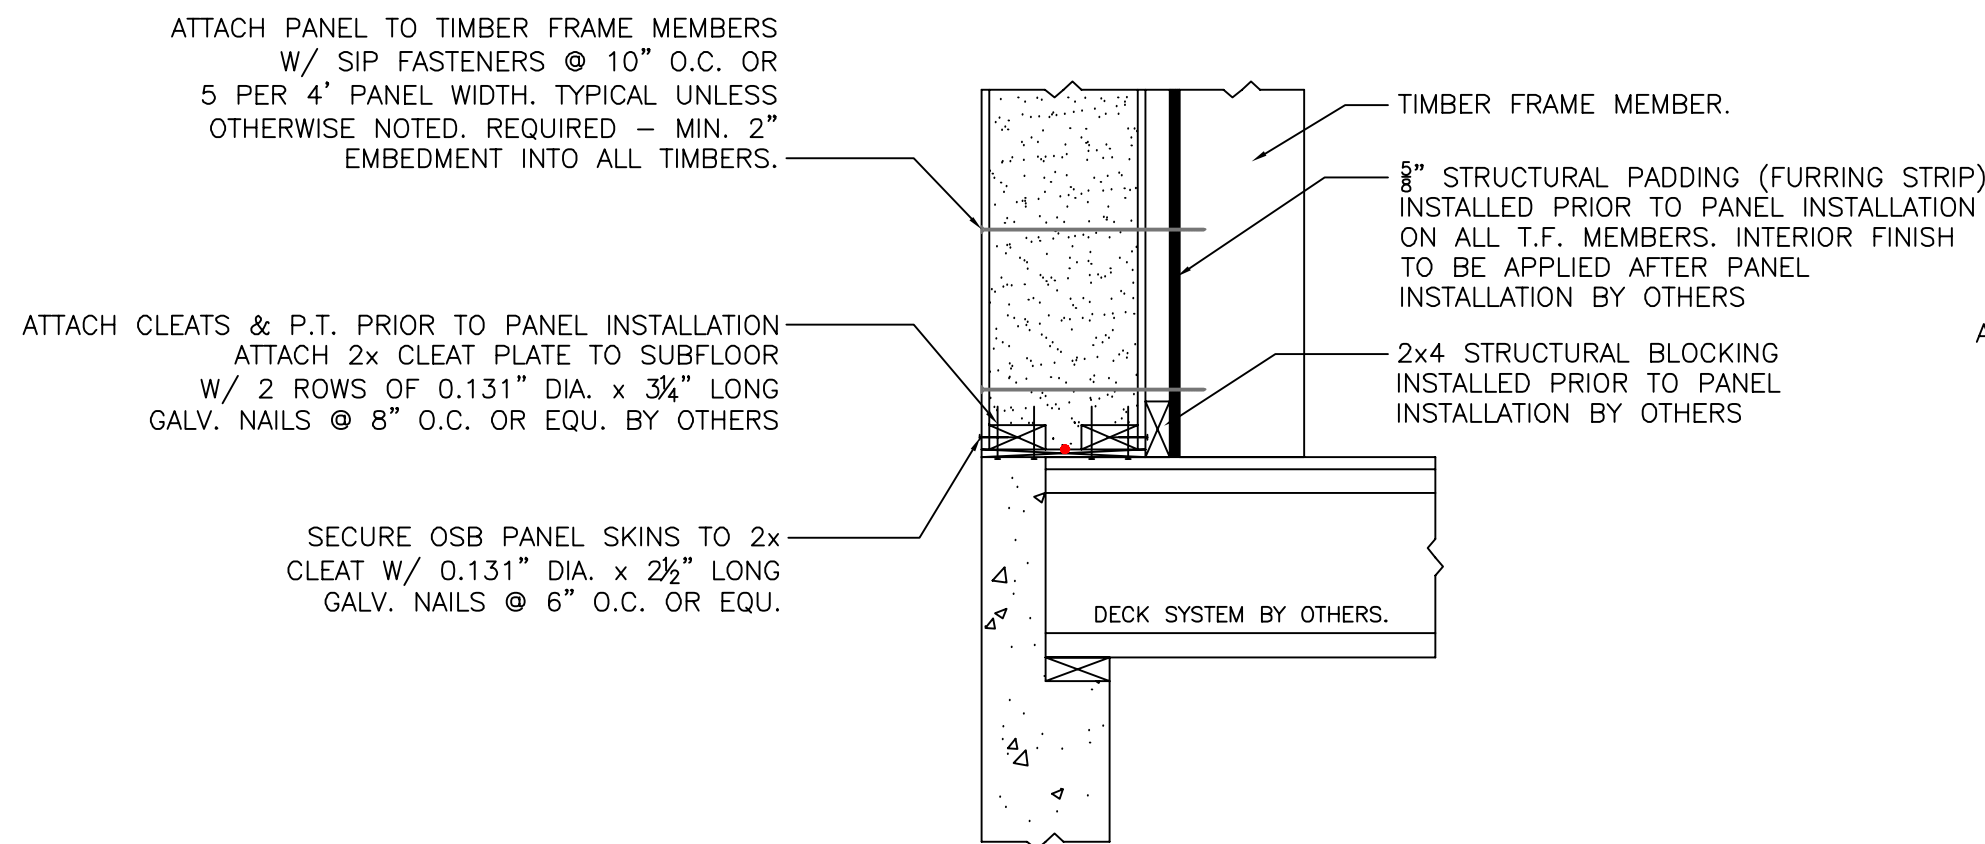


NOTE: ALL RED DOTS - APPLY CONTINUOUS  
3/8" DIA. BEAD OF MASTIC SEALANT  
BETWEEN 2x MEMBER & PANEL FOAM.

PANEL TYPE: STRUCTURAL PANELS APPLIED DIRECTLY TO PADDED FRAME

PANEL SILL CONNECTION  
SCALE: 1" = 1'-0"

5

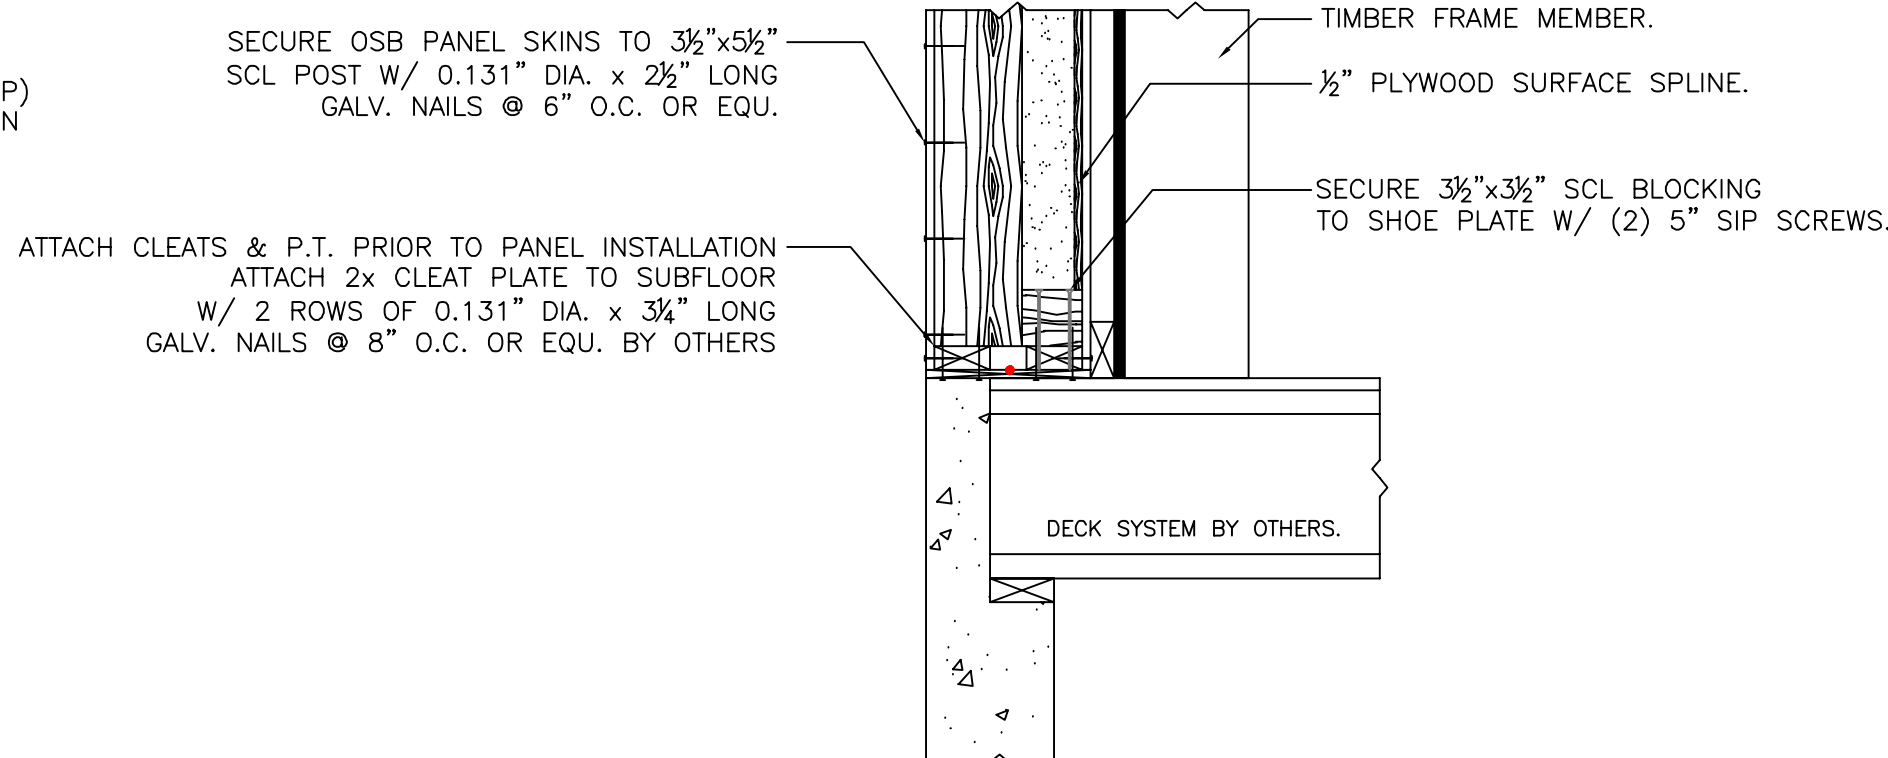


NOTE: ALL RED DOTS - APPLY CONTINUOUS  
3/8" DIA. BEAD OF MASTIC SEALANT  
BETWEEN 2x MEMBER & PANEL FOAM.

PANEL TYPE: STRUCTURAL PANELS APPLIED DIRECTLY TO PADDED FRAME

PANEL SILL CONNECTION @ EMBEDDED POST  
SCALE: 1" = 1'-0"

6

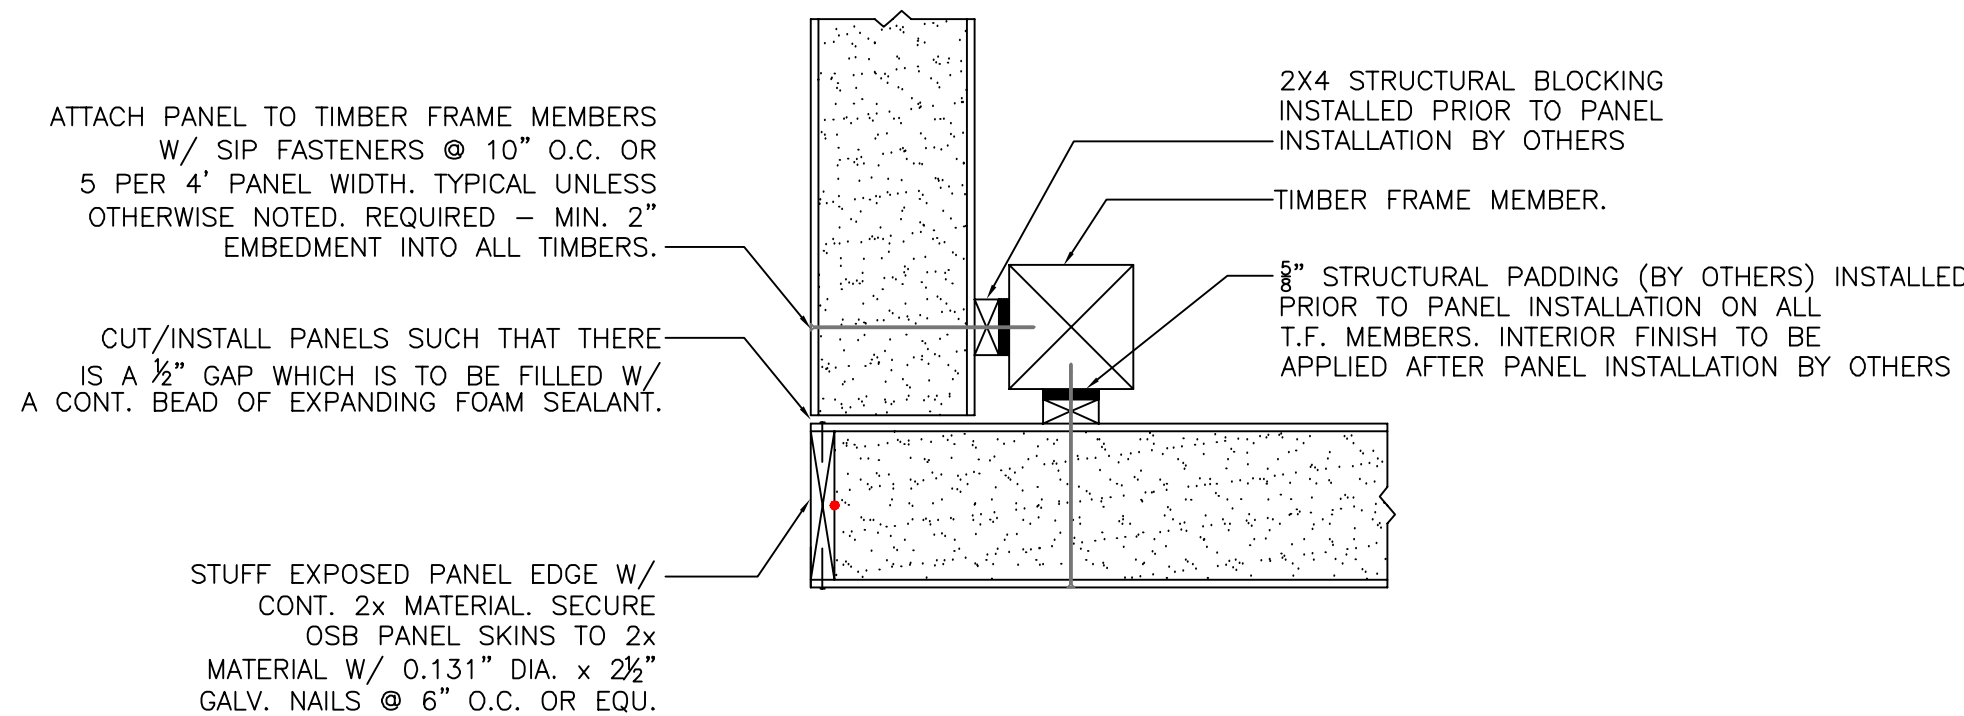


NOTE: ALL RED DOTS - APPLY CONTINUOUS  
3/8" DIA. BEAD OF MASTIC SEALANT  
BETWEEN 2x MEMBER & PANEL FOAM.

PANEL TYPE: STRUCTURAL PANELS APPLIED DIRECTLY TO PADDED FRAME

PANEL CORNER CONNECTION DETAIL  
SCALE: 1" = 1'-0"

7

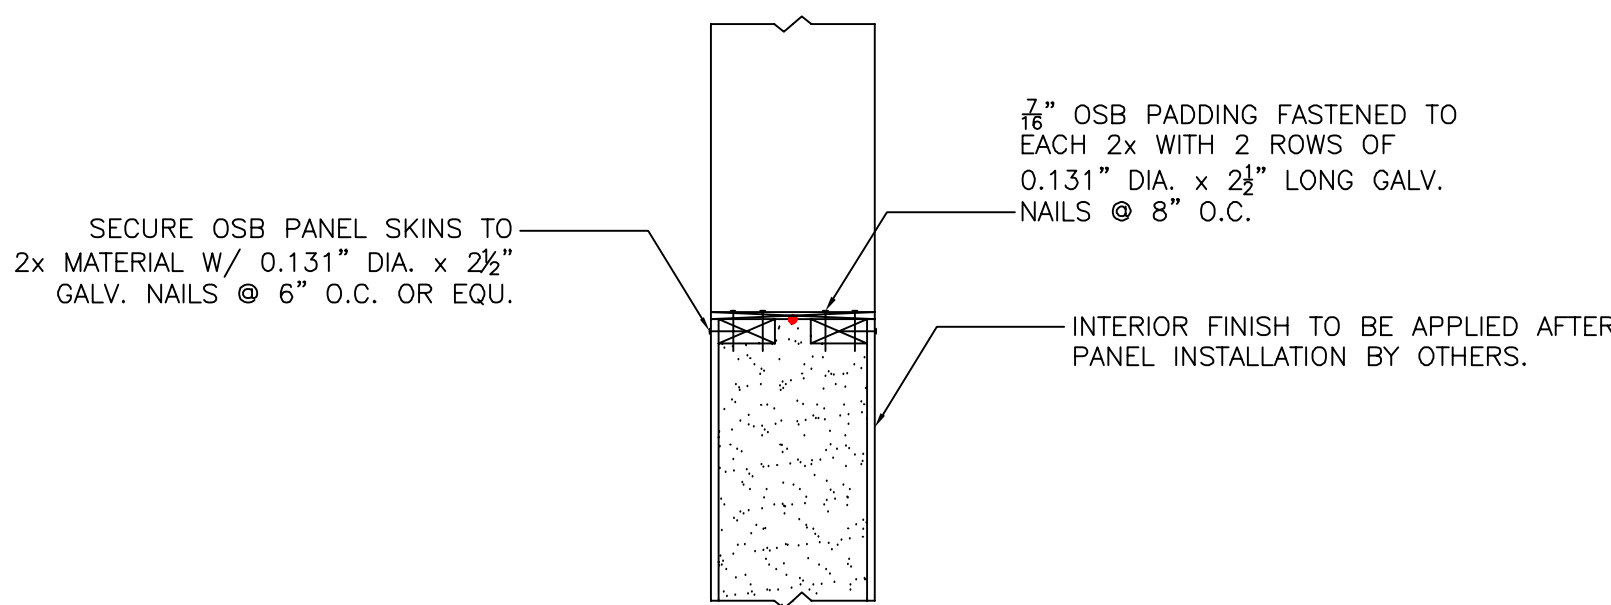


NOTE: ALL RED DOTS - APPLY CONTINUOUS  
3/8" DIA. BEAD OF MASTIC SEALANT  
BETWEEN 2x MEMBER & PANEL FOAM.

PANEL TYPE: STRUCTURAL PANELS APPLIED DIRECTLY TO PADDED FRAME

PANEL ROUGH OPENING EDGE DETAIL  
SCALE: 1" = 1'-0"


8

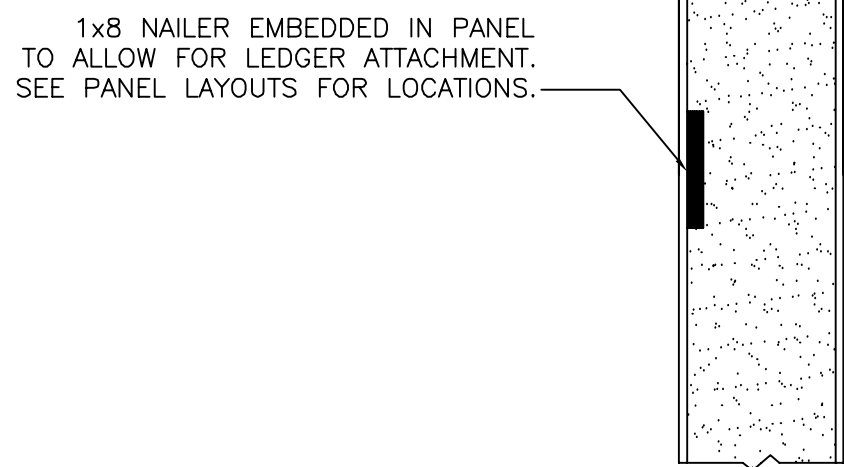

PANEL TYPE: STRUCTURAL PANELS APPLIED DIRECTLY TO PADDED FRAME

EMBEDDED LEDGER DETAIL  
SCALE: 1" = 1'-0"

9

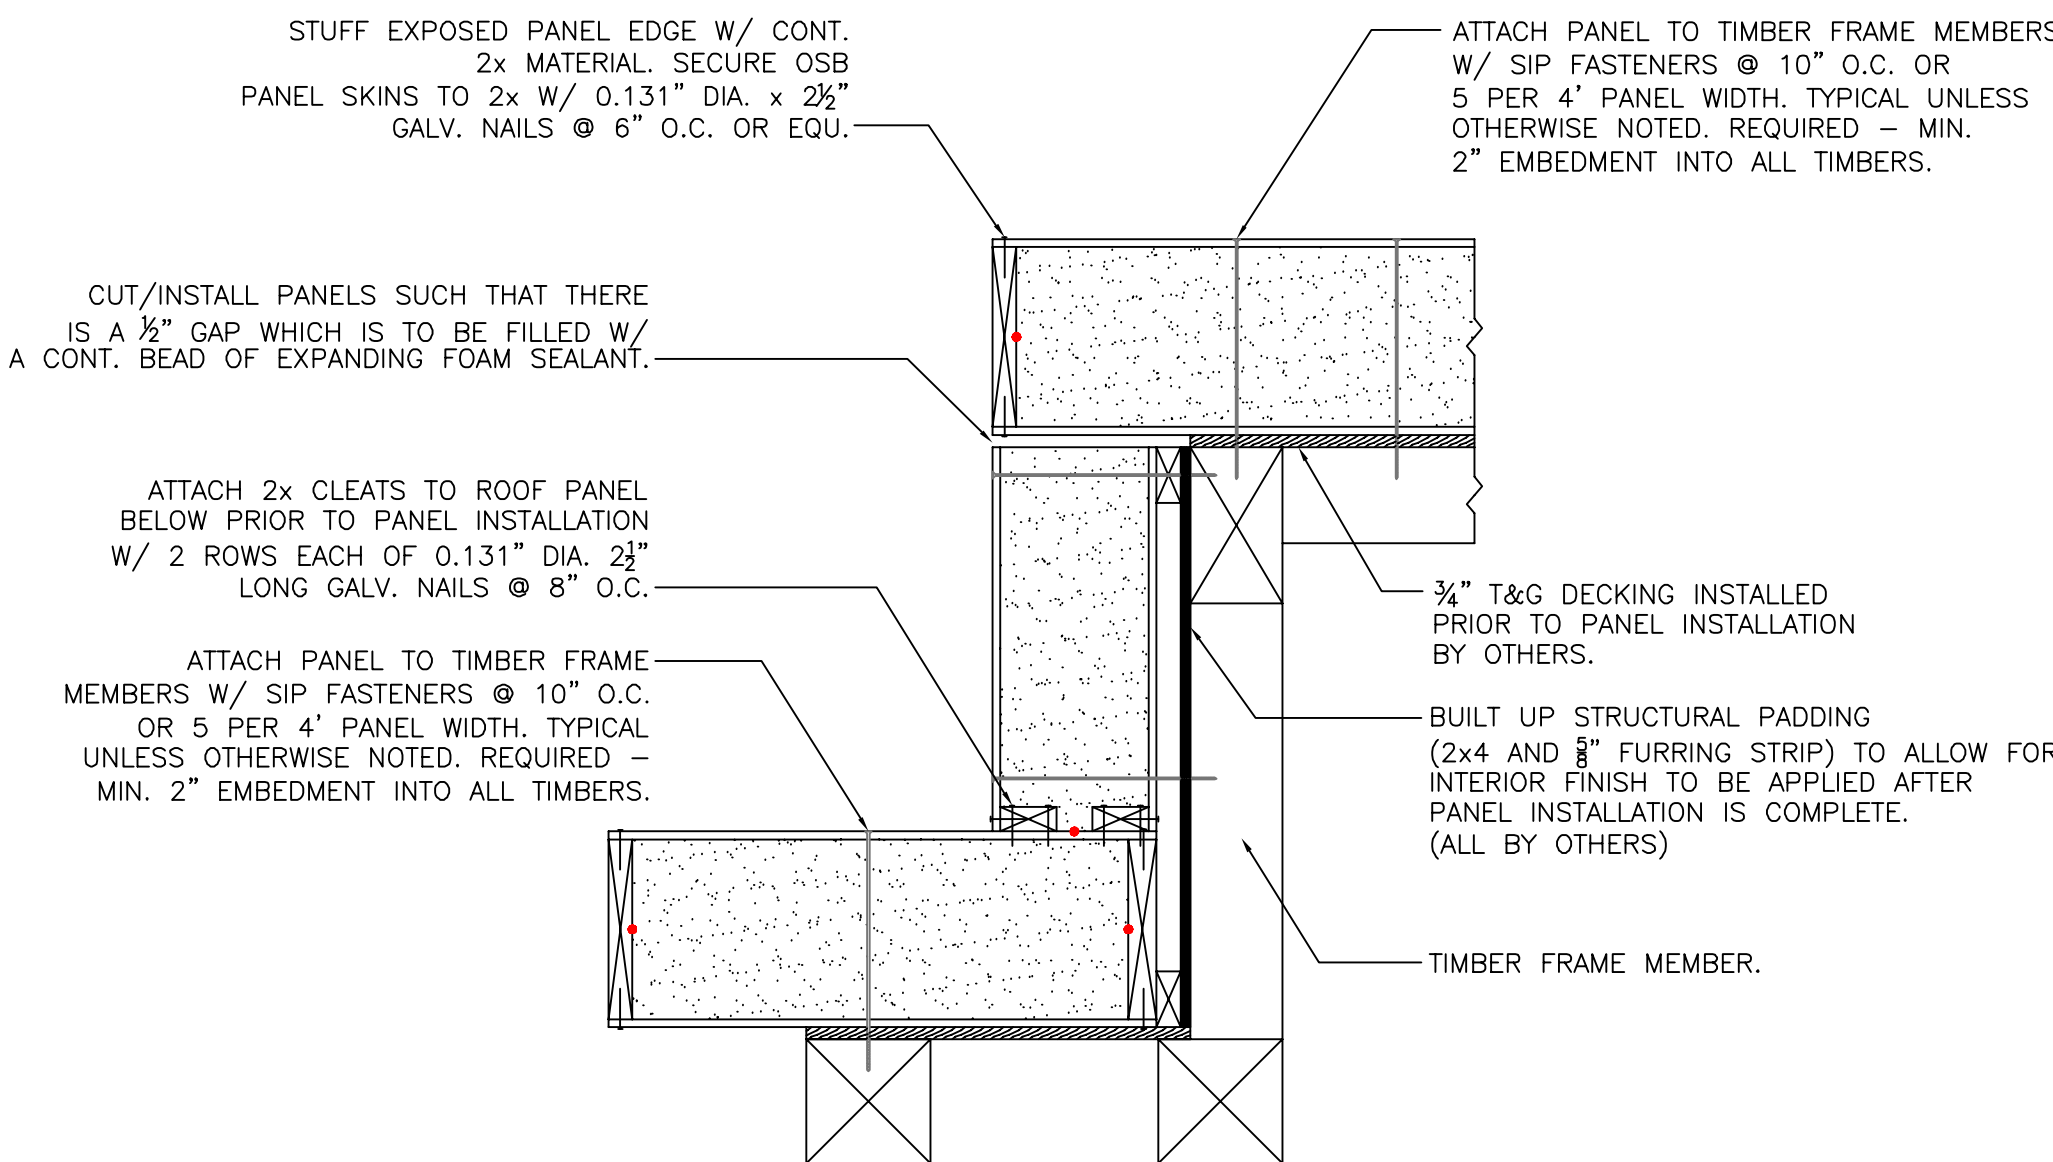

NOTE: ALL RED DOTS - APPLY CONTINUOUS  
3/8" DIA. BEAD OF MASTIC SEALANT  
BETWEEN 2x MEMBER & PANEL FOAM.

DORMER CHEEK DETAIL  
SCALE: 1" = 1'-0"

10

TITLE SZAUTER RESIDENCE  
LOCATION CARROLL, NH

DRAWING TITLE  
PANEL LAYOUT DRAWINGS

DRAWN BY: JEC JOB CONTACT: NEAL @ FOARD PANEL

CHECKED BY: DATE: DECEMBER 2, 2014

DRAWING NO.

PL-11

SHEET NO.

11 of 12